

PROJECT TEAM:

YARDARM GROUP OWNER/DEVELOPER

2440 W COMMODORE WAY

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SEATTLE, WA 98199

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ARCHITECT

NASH AND ASSOCIATES ARCHITECTS 8003 | 18TH AVE NE

KIRKLAND, WA 98033

(425) 242-7490

CODES AND COMPLIANCES

2018 IRC, 2018 MSEC

FIRE SPRINKLER NOTE

AN NFPAI3D FIRE SPRINKLER SYSTEM IS REQUIRED. EACH UNIT (LOT) IS SEPERATED BY AN I" INCH AIR SPACE AND EACH UNIT'S ONE HOUR PARTY WALL PER DETAIL ON A-12

HEATING NOTE

ELECTRIC DUCTLESS HEAT PUMP HEAT FOR ALL PRIMARY SPACES

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A7- UPPER FLOOR FRAMING PLAN

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DI- RATED WALL DETAILS

LI- LATERAL DETAILS

GI- TYPICAL WALL-DESIGN DATA

UNIT TYPE 'A' SQUARE FOOTAGE'S:

LOWER FLOOR	93 S.F.
MAIN FLOOR	665 S.F.
UPPER FLOOR	627 S.F.
TOTAL	1,385 S.F.
GARAGE	516 S.F.
CVRD. PORCH	25 S.F.

UNIT TYPE 'B' SQUARE FOOTAGE'S:

LOWER FLOOR	93 S.F.
MAIN FLOOR	665 S.F.
UPPER FLOOR	611 S.F.
TOTAL	1,369 S.F.
GARAGE	516 S.F.
CVRD. PORCH	25 S.F.

FLASHING NOTE

APPROVED CORROSION-RESISTANT FLASHING SHALL BE APPLIED SHINGLE FASHION IN SUCH A MANNER TO PREVENT ENTRY OF WATER INTO THE WALL CAVITY OR PENETRATION OF WATER INTO THE BUILDING STRUCTURAL FRAMING COMPONENTS THE FLASHING SHALL EXTEND TO THE SURFACE OF

THE EXTERIOR WALL FINISH. APPROVED CORROSION RESISTANT FLASHING SHALL BE INSTALLED AT THE FOLLOWING LOCATIONS:

I. EXTERIOR WINDOW AND DOOR OPENINGS. FLASHING AT EXTERIOR WINDOW AND DOOR OPENINGS SHALL EXTEND TO THE SURFACE OF THE EXTERIOR WALL FINISH OR TO THE WATER RESISTIVE BARRIER FOR SUBSEQUENT

2. AT THE INTERSECTION OF CHIMNEYS OR OTHER MASONRY CONSTRUCTION WITH FRAME OR STUCCO WALLS

3. UNDER AND AT THE ENDS OF MASONRY, WOOD, OR METAL COPINGS AND SILLS

4. CONTINUOUSLY ABOVE ALL PROJECTING WOOD TRIM

5. WHERE EXTERIOR PORCHES, DECKS, OR STAIRS ATTACH TO A WALL OR FLOOR ASSEMBLY OF WOOD FRAME

CONSTRUCTION 6. AT WALL AND ROOF INTERSECTIONS

7. AT BUILT IN GUTTERS

ADDRESS NOTE:

ADDRESS NUMBERS SHALL BE A MINIMUM 4" HIGH WITH A MINIMUM STROKE WIDTH OF 1/2" AND TO BE ON A CONTRASTING BACKGROUND PER IRC 319.1



6-22-22 permit: revisions: 5-1-23

drawn by: LMD checked by: MMJ





FACADE AREA = 2725 SQFT

TRANSPARENCY AREA = 540 SQFT (19.8%)

(FACADE SOFT YERIFIED USING AUTOCAD AREA



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YARDARM GROUP POPLAR POINT UNITS II-16

roject:

date: 6-22-22 permit: revisions:


drawn by: LMD checked by: MWJ

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	HOLDDOWN SCHEDULE					
М	IARK	HOLDOWN/ STRAP	FASTENERS	MOOD MEMBER THICKNESS/SPECIES	ANCHOR REQUIRED	
-	Τ-Ι	STHDI4/I4 RJ	24-16d SINKERS	(2) 2X4/2X6 STUDS HF/SPF		
-	T-2	MST48	(34)-16d	(2) 2X4/2X6 STUDS HF/SPF		
-	T-3	MST72	(68)-10d	(2) 2X4/2X6 STUDS HF/SPF		
-	T-4	MSTC48B3	(38)-10d	(2) 2X4/2X6 STUDS HF/SPF		
-	T-5	HDU8-SDS2.5	(20) SDS 1/4" X 2-1/2"	(2) 2X4/2X6 STUDS HF/SPF	7/8" ANCHOR BOLT	
-	T-6	HDI2	(4) I" STUD BOLTS	(3) 2X4/2X6 STUDS HF/SPF	SBIX30 MIN. EMBEDMENT IS 24" WALL MINIMUM 30" TALL WALL AT THESE LOCATIONS	

SHEAR NOTE:

I. 3X MATERIAL CAN BE USED FOR
ALL MUDSILLS
2. SET A DOUBLE 2X STUD BEHIND
EVERY STHDI4 HOLDOWN CALLED OUT
ON THE FOUNDATION PLAN. SET HOLDOWN
I/2" MINIMUM AWAY FROM WALL CORNERS,
WINDOW AND DOOR HEADERS. IT IS IMPORTANT
THAT THE FOUNDATION CONTRACTOR HAS THE
MAIN FLOOR PLAN SHEET TO PROPERLY
LAYOUT HOLDOWNS.
3. A MST48 STRAP WITH (2) I/2" BOLTS INTO
THE FOUNDATION IS A PROPER FIX FOR
A MISPLACED STHDI4 HOLDOWN.
NOTES:

ALL WOOD IN CONTACT WITH CONCRETE SHALL BE PRESSURE TREATED OR CEDAR.

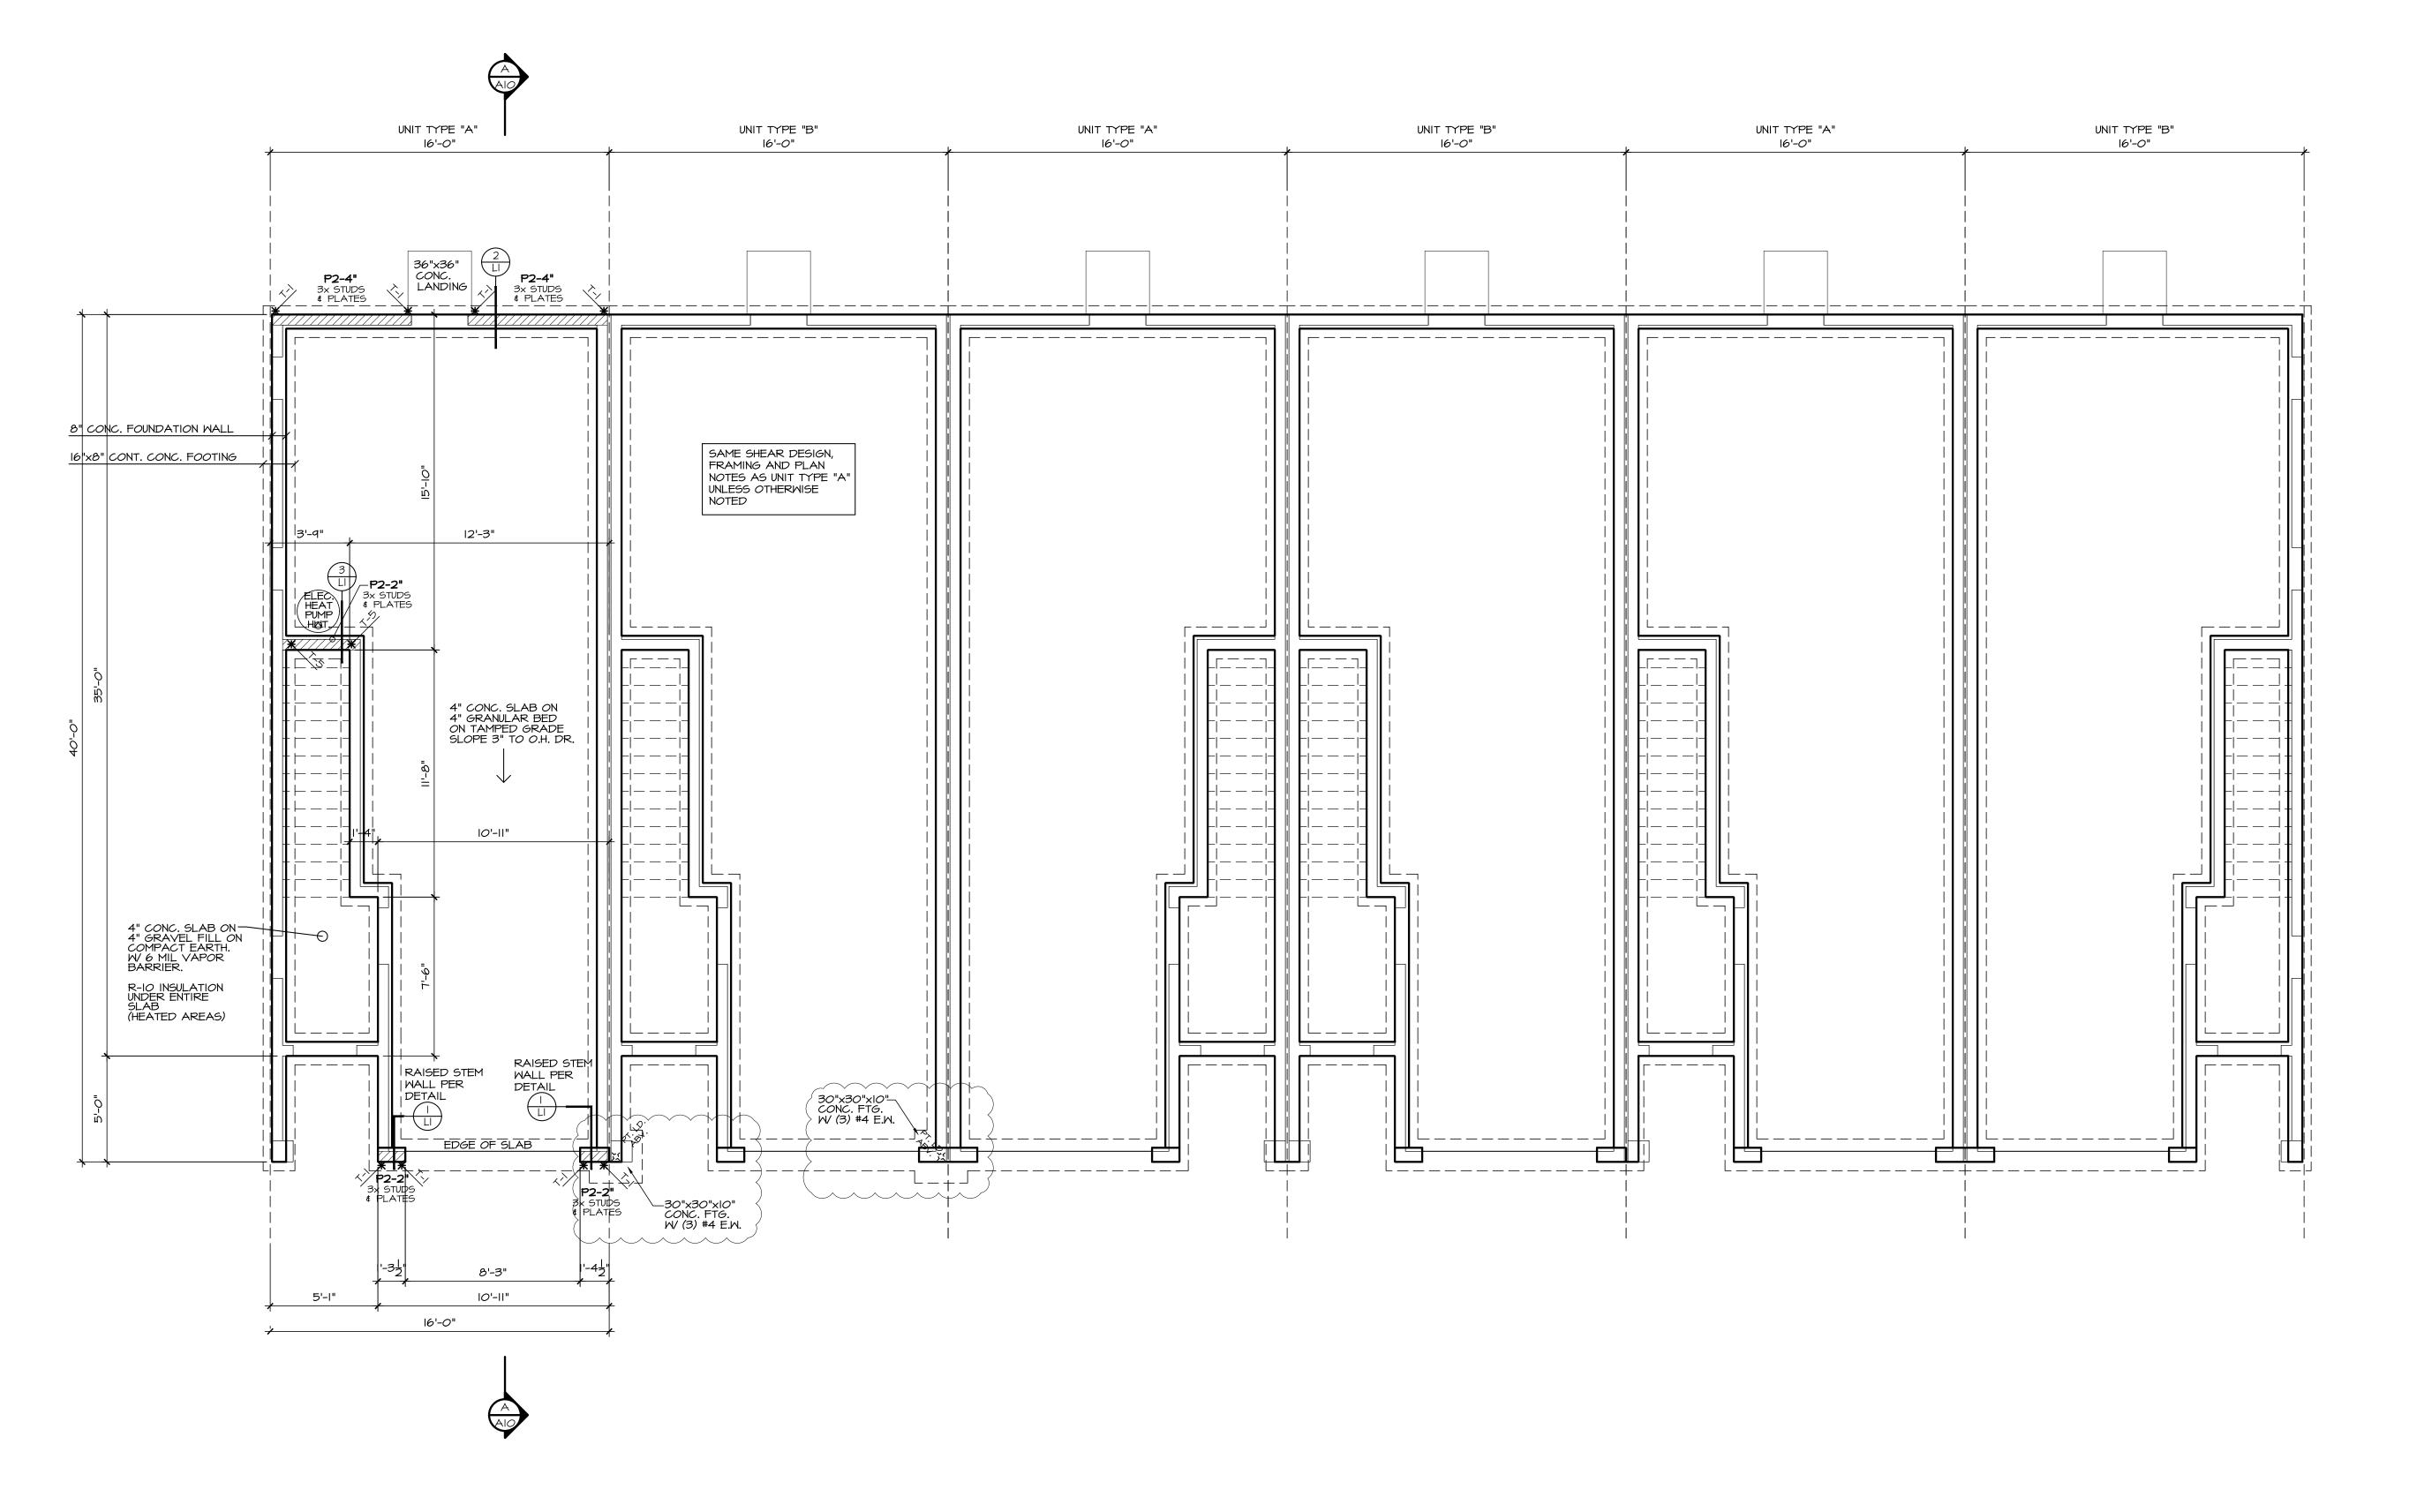PROVIDE CRAWL DRAIN @ LOW POINT IN CRAWLSPACE.

SOLID BLOCKING UNDER ALL BEARING WALLS.


SLOPE ALL CONC, STOOPS AND/OR PATIOS 1/4" PER FOOT AWAY FROM DOORWAYS. *** SHEAR NOTE:

SEE SHEET LI FOR SHEAR WALL
NAILING SCHEDULE, & DETAILS.

FOUNDATION PLAN

SEE GENERAL NOTES

SCALE: 1/4" = 1'-0"

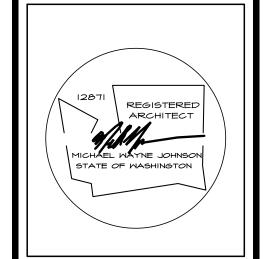

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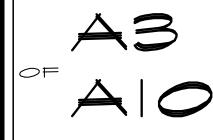
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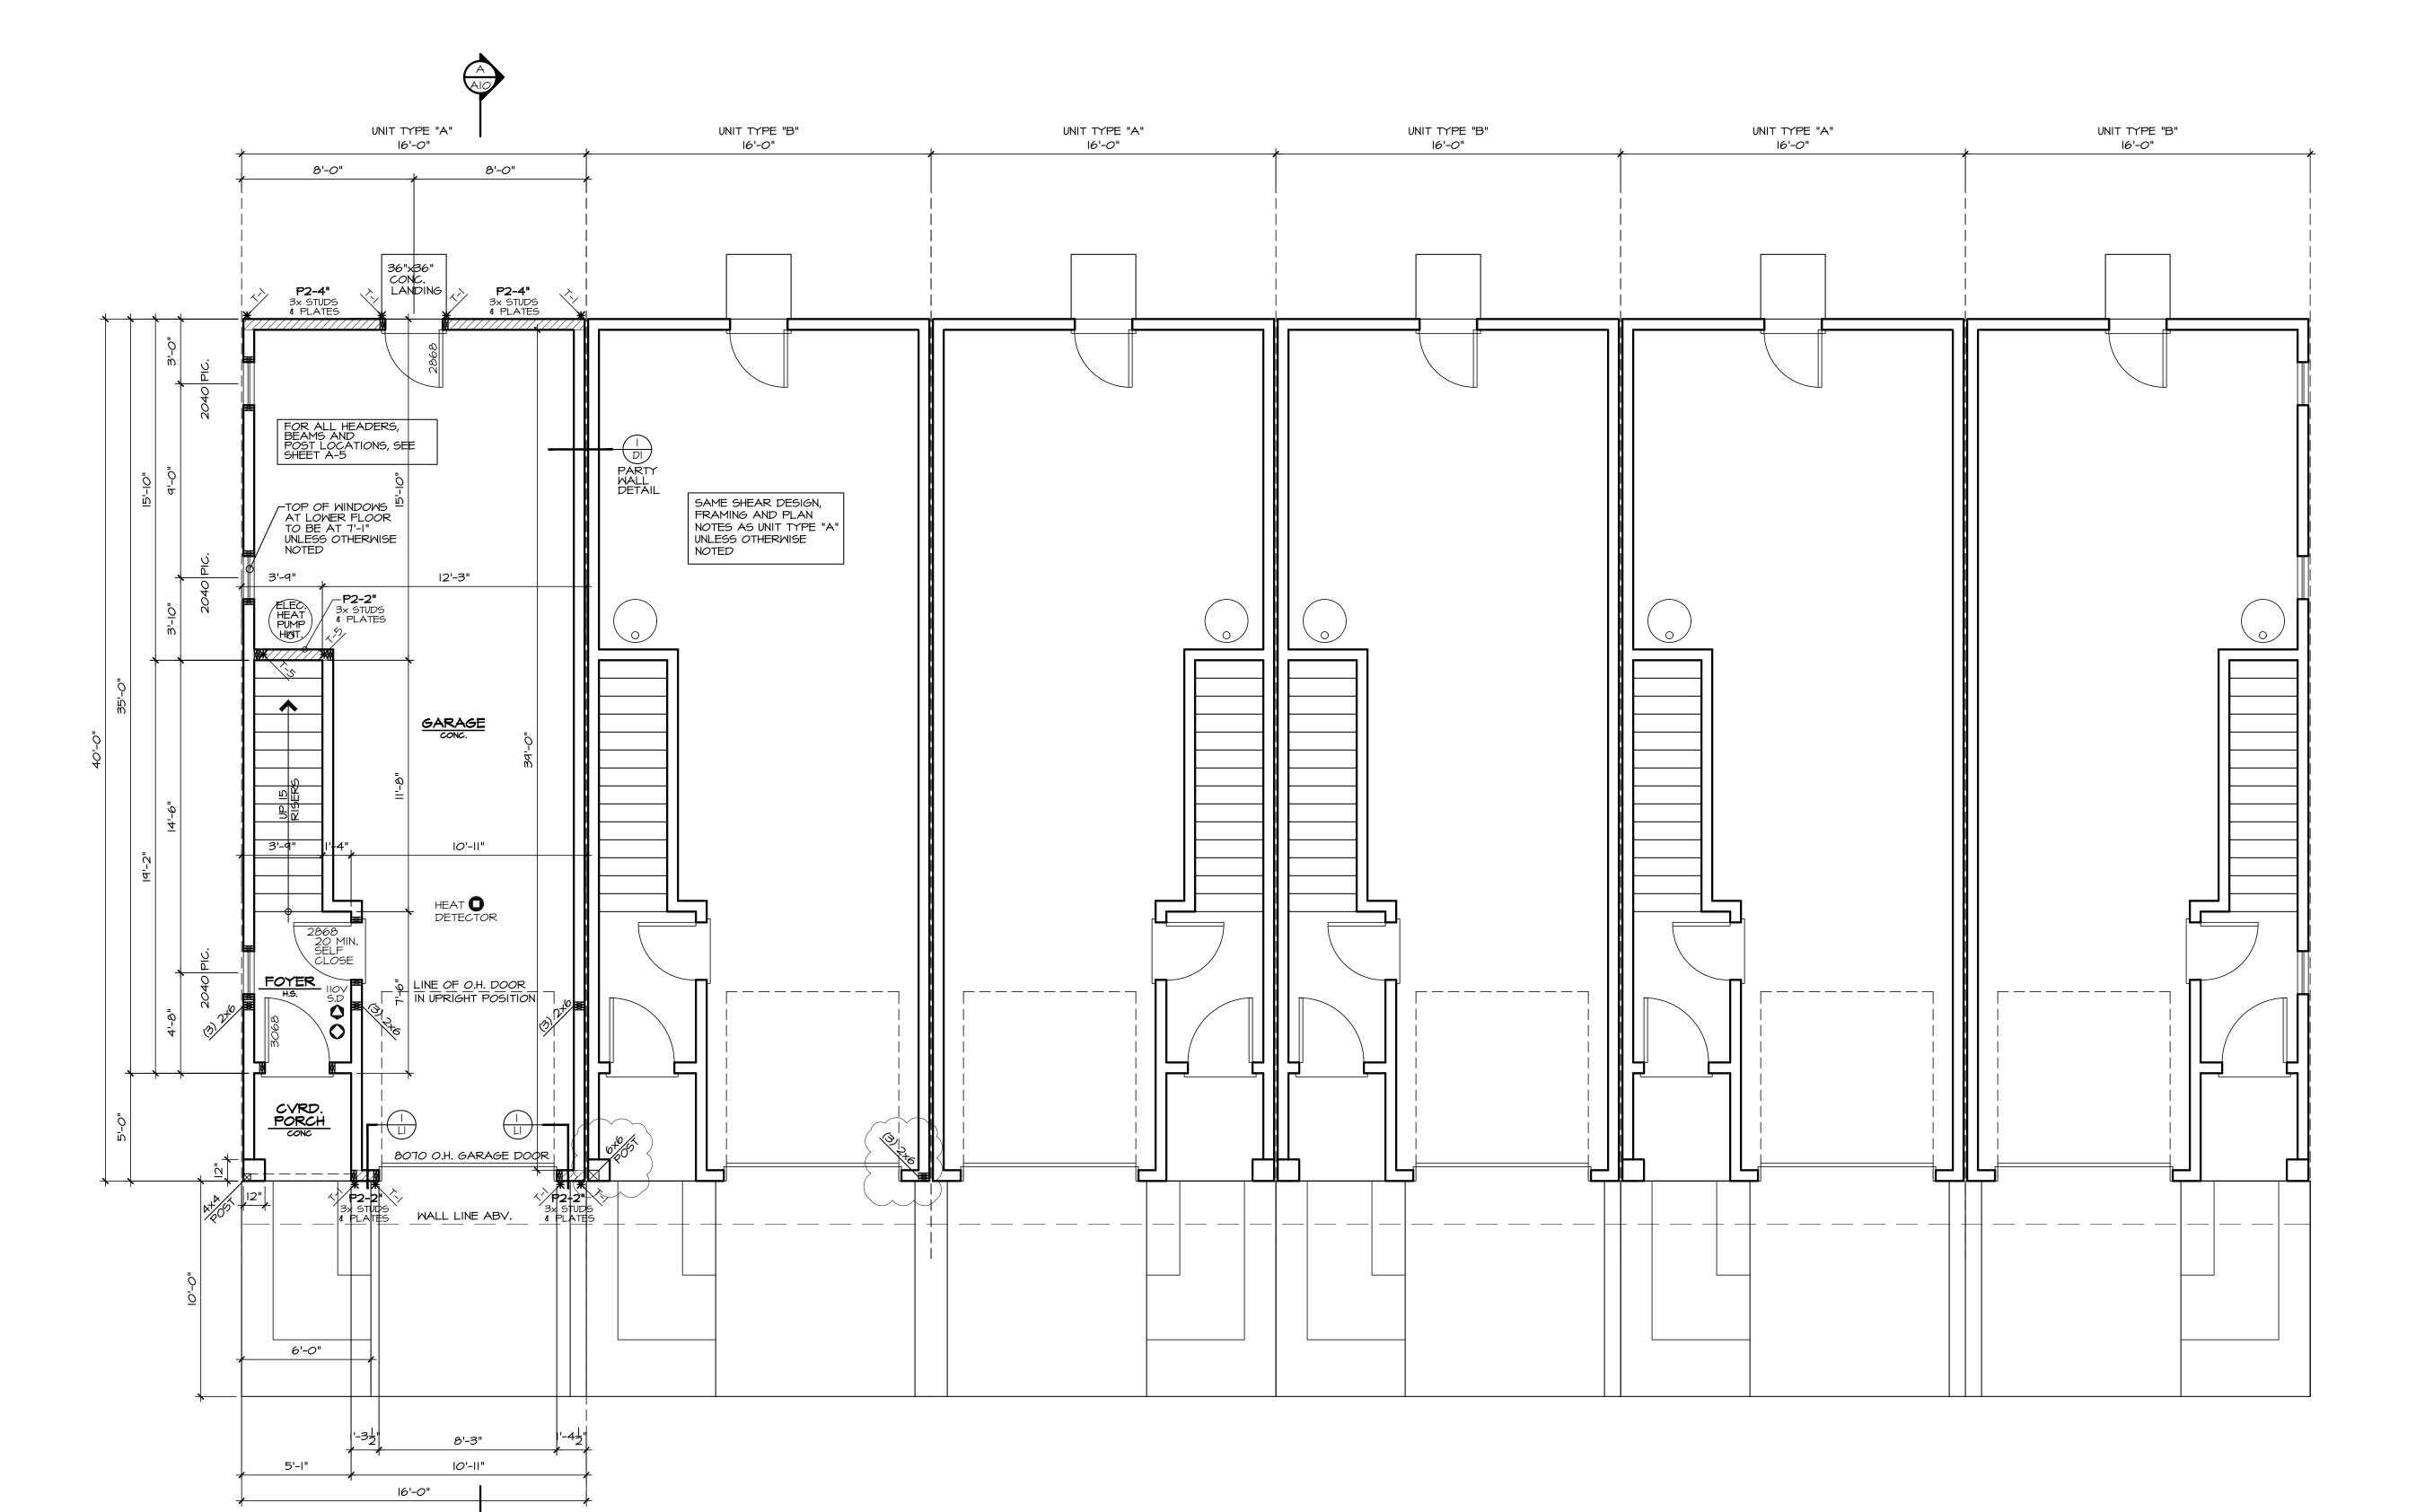
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YARDARM GROUP POPLAR POINT UNITS II-16

date: 6-22-22 permit: revisions: 5-1-23

drawn by: LMD checked by: MMJ





HOLDDOWN SCHEDULE						
MARK	HOLDOWN/ STRAP	FASTENERS	WOOD MEMBER THICKNESS/SPECIES	ANCHOR REQUIRED		
Т-1	STHD14/14 RJ	24-16d SINKERS	(2) 2X4/2X6 STUDS HF/SPF			
T-2	MST48	(34)-16d	(2) 2X4/2X6 STUDS HF/SPF			
T-3	MST72	(68)-10d	(2) 2X4/2X6 STUDS HF/SPF			
T-4	MSTC48B3	(38)-10d	(2) 2X4/2X6 STUDS HF/SPF			
T-5	HDU8-SDS2.5	(20) SDS 1/4" X 2-1/2"	(2) 2X4/2X6 STUDS HF/SPF	7/8" ANCHOR BOLT		
T-6	HDI2	(4) I" STUD BOLTS	(3) 2X4/2X6 STUDS HF/SPF	SBIX30 MIN. EMBEDMENT IS 24" WALL MINIMUM 30" TALL WALL AT THESE I COLATIONS		

ALL EXTERIOR WARM WALLS TO BE 2 X 6 STUDS @ 16" O.C. TYPICAL. ALL INTERIOR WALLS TO BE 2 X 4 STUDS @ 16" O.C. TYPICAL. ALL HEADERS TO BE 4XIO DF#2 UNLESS NOTED OTHERWISE. FUR-OUT HEADERS TO MATCH 2 imes 6 WALLS.

SOLID BLOCKING UNDER ALL BEARING WALLS. TUB/SHOWER UNITS SHALL HAVE FIRE BLOCKING BETWEEN WALL STUDS AND WATERPROOF SURROUNDS TO +72" FROM DRAIN. GLAZING, INCLUDING WINDOWS WITHIN +72" OF DRAIN, SHALL BE SAFTEY GLASS. SHOWER FLOW IS LIMITED TO 1.75 GAL/MIN.

EXHAUST FANS LARGER THAN 50CFM MAY BE CONNECTED TO 4" SMOOTH WALL VENT PIPE IF RUNS DO NOT EXCEED 20' IN LENGTH. THE MINIMUM SIZE OF FLEX DUCT IS 5" DIAMETER WITH A MAXIMUM RUN OF 15' COMBUSTION AIR REQUIRED FOR ALL FUEL BURNING APPLIANCES

BEARING ABOVE FLOOR LINE ABOVE POINT LOAD ABOVE SMOKE DETECTOR IIOV INTERCONNECTED W/ BATTERY BACK-UP. PER IRC 314

LEGEND:

CARBON MONOXIDE DETECTOR PER IRC 315 HEAT DETECTOR

*** SHEAR NOTE: SEE SHEET LI FOR SHEAR WALL NAILING SCHEDULE, & DETAILS.

SMOKE DETECTORS SHALL BE INSTALLED NOT LESS THAN 3 FEET HORIZONTALLY FROM THE DOOR OR OPENING OF A BATHROOM THAT CONTAINS A TUB OR SHOWER PER R314 IONIZATION SMOKE ALARMS:
SHALL NOT BE INSTALLED LESS THAN
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APPLIANCE. PHOTO ELECTRIC SMOKE ALARMS:
SHALL NOT BE INSTALLED LESS THAN 6'
HORIZONTALLY FROM A PERMANENTLY
INSTALLED COOKING APPLIANCE PER R314

LOMER FLOOR PLAN


SEE GENERAL NOTES

SCALE: 1/4" = 1'-0"



6-22-22 date: permit: revisions: 5-1-23

drawn by: LMD checked by: MMJ

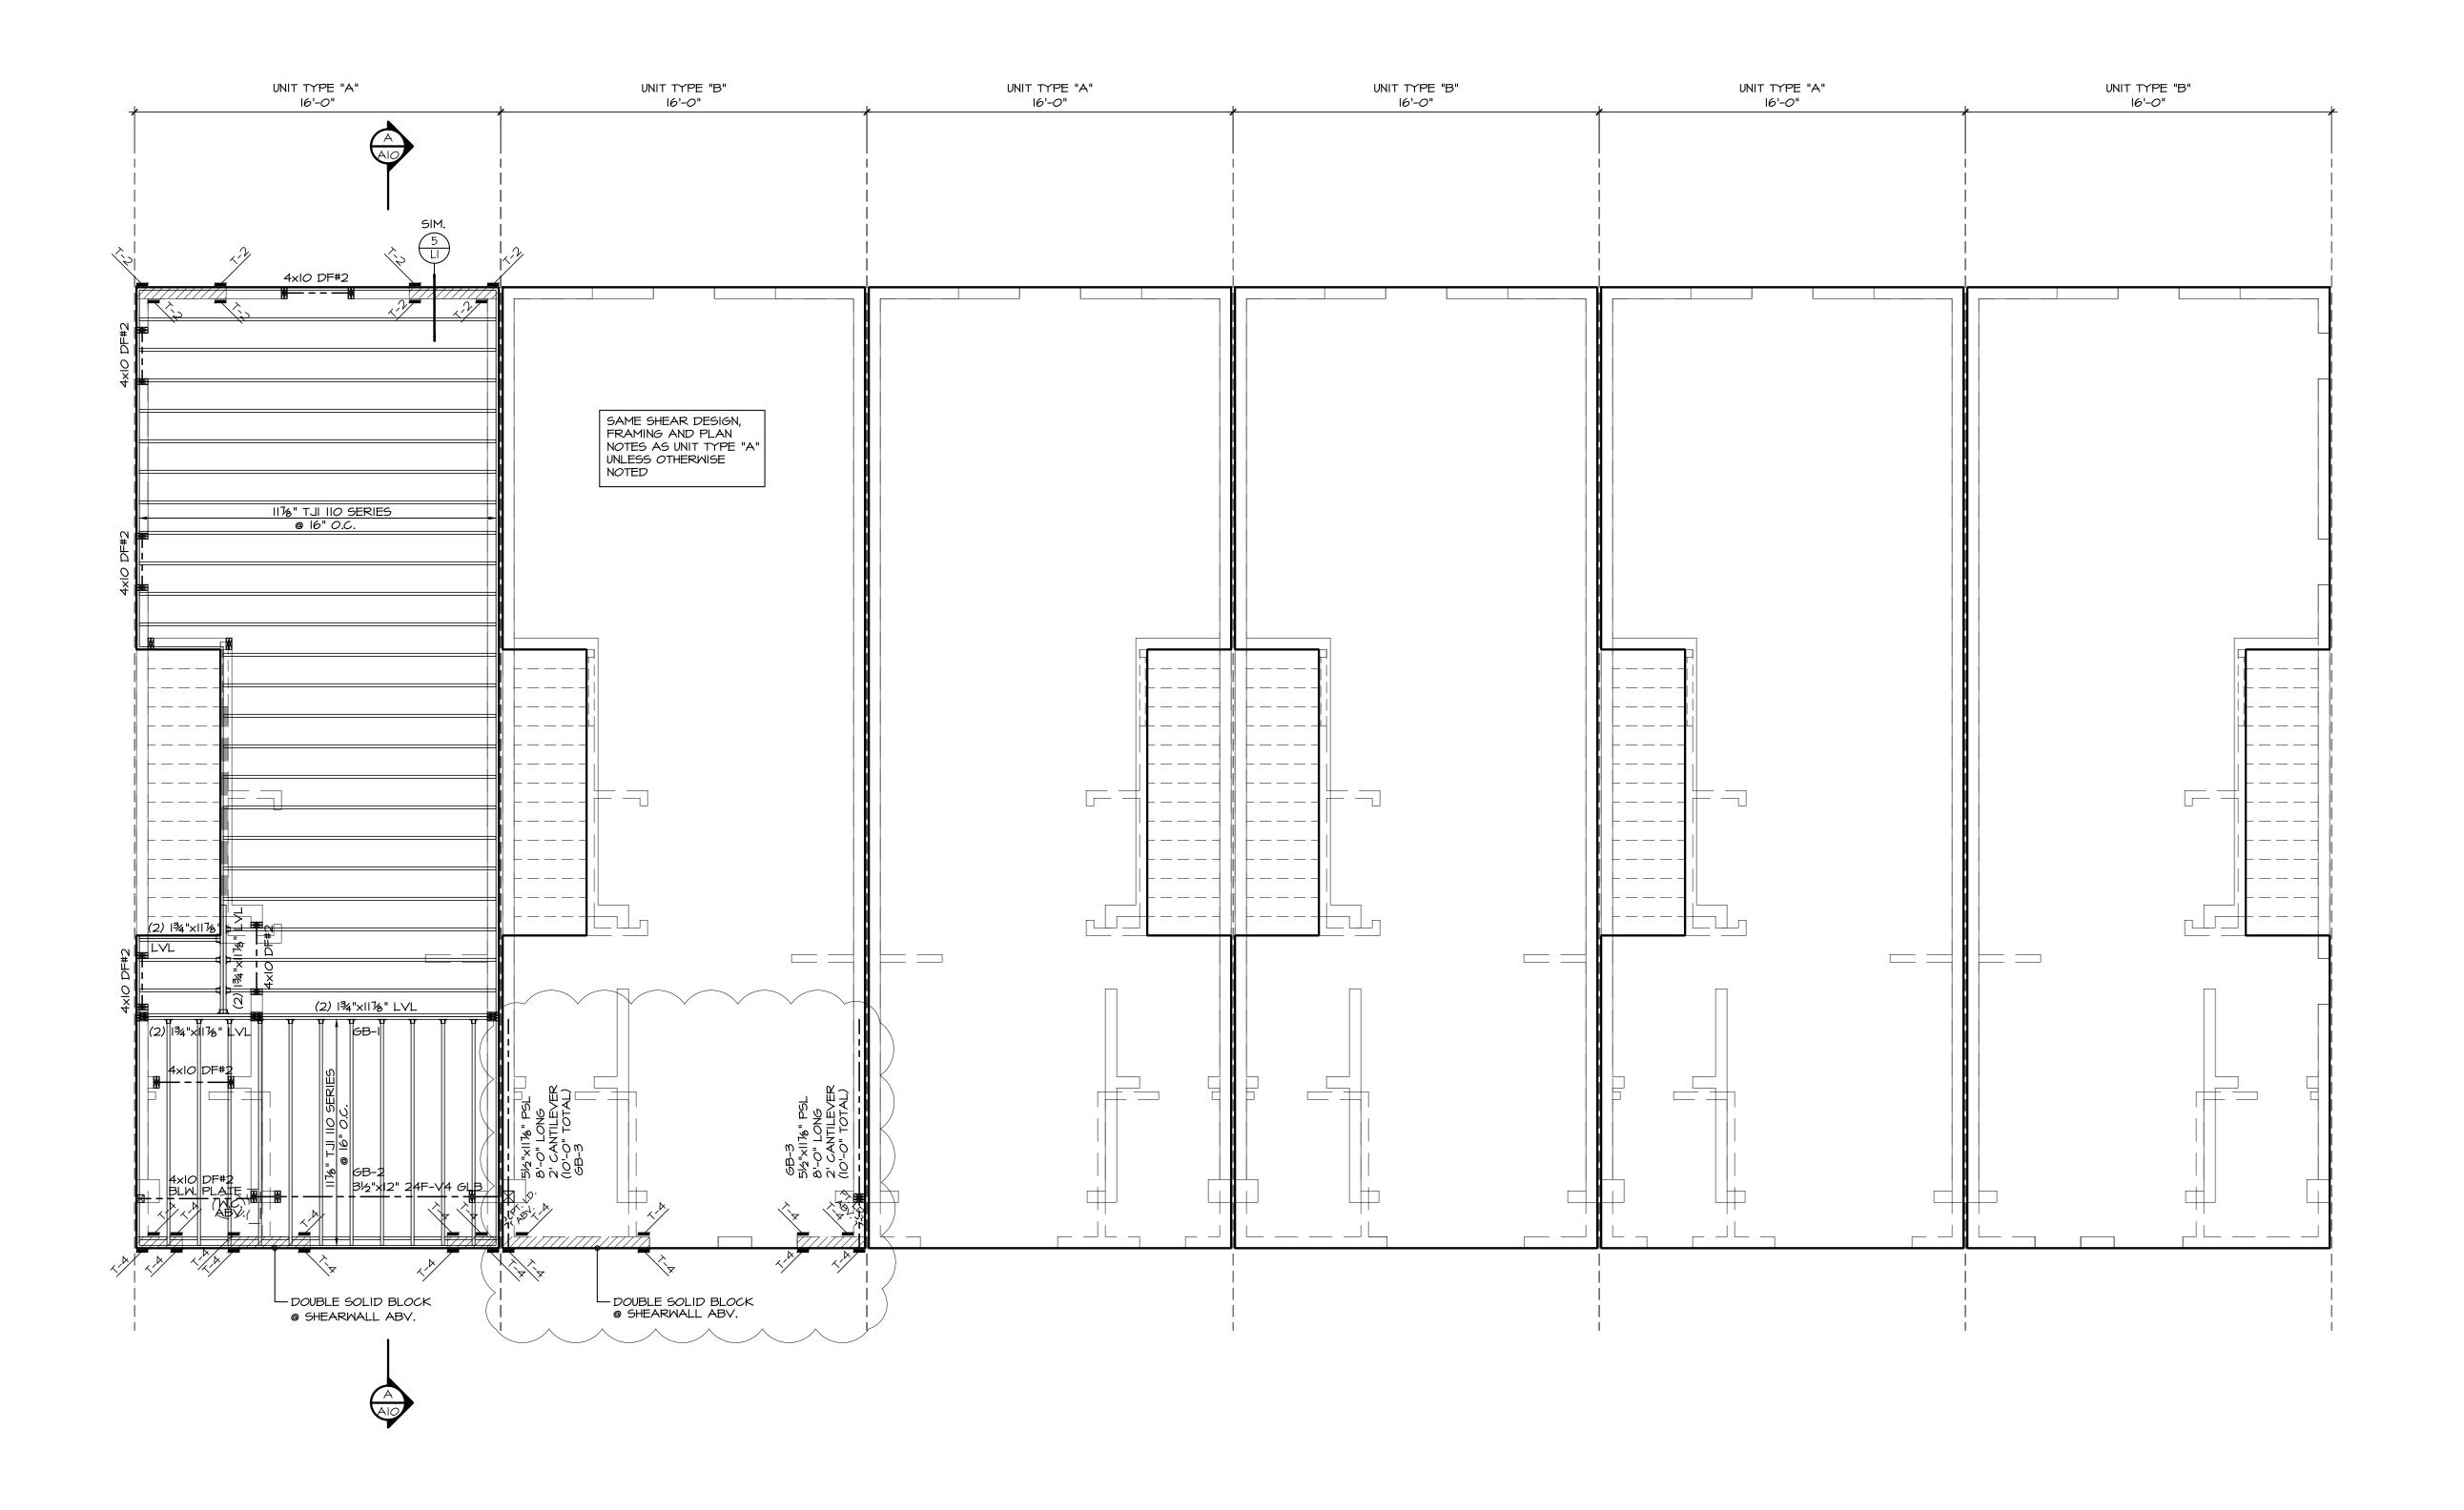

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T-5	HDU8-SDS2.5	(20) SDS 1/4" X 2-1/2"	(2) 2X4/2X6 STUDS HF/SPF	7/8" ANCHOR BOLT	
T-6	HDI2	(4) I" STUD	(3) 2X4/2X6 STUDS HF/SPF	SBIX30 MIN. EMBEDMENT 15 24" WALL	

ALL EXTERIOR WARM WALLS TO BE 2 X 6 STUDS @ 16" O.C. TYPICAL.

ALL INTERIOR WALLS TO BE 2 X 4 STUDS @ 16" O.C. TYPICAL. ALL HEADERS TO BE 4X10 DF#2 UNLESS NOTED OTHERWISE. FUR-OUT HEADERS TO MATCH 2 \times 6 MALLS.

SOLID BLOCKING UNDER ALL BEARING WALLS.

TUB/SHOWER UNITS SHALL HAVE FIRE BLOCKING BETWEEN WALL STUDS AND WATERPROOF SURROUNDS TO +72" FROM DRAIN. GLAZING, INCLUDING WINDOWS WITHIN +72" OF DRAIN, SHALL BE SAFTEY GLASS. SHOWER FLOW IS LIMITED TO 1.75 GAL/MIN.

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LEGEND: BEARING ABOVE FLOOR LINE ABOVE

POINT LOAD ABOVE SMOKE DETECTOR
IIOV INTERCONNECTED
W/ BATTERY BACK-UP.
PER IRC 314

CARBON MONOXIDE DETECTOR PER IRC 315

*** SHEAR NOTE: SEE SHEET LI FOR SHEAR WALL NAILING SCHEDULE, & DETAILS. MAIN FLOOR FRAMING PLAN


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LEGEND:

BEARING ABOVE

FLOOR LINE ABOVE

PT. LD.
ABOVE

POINT LOAD ABOVE

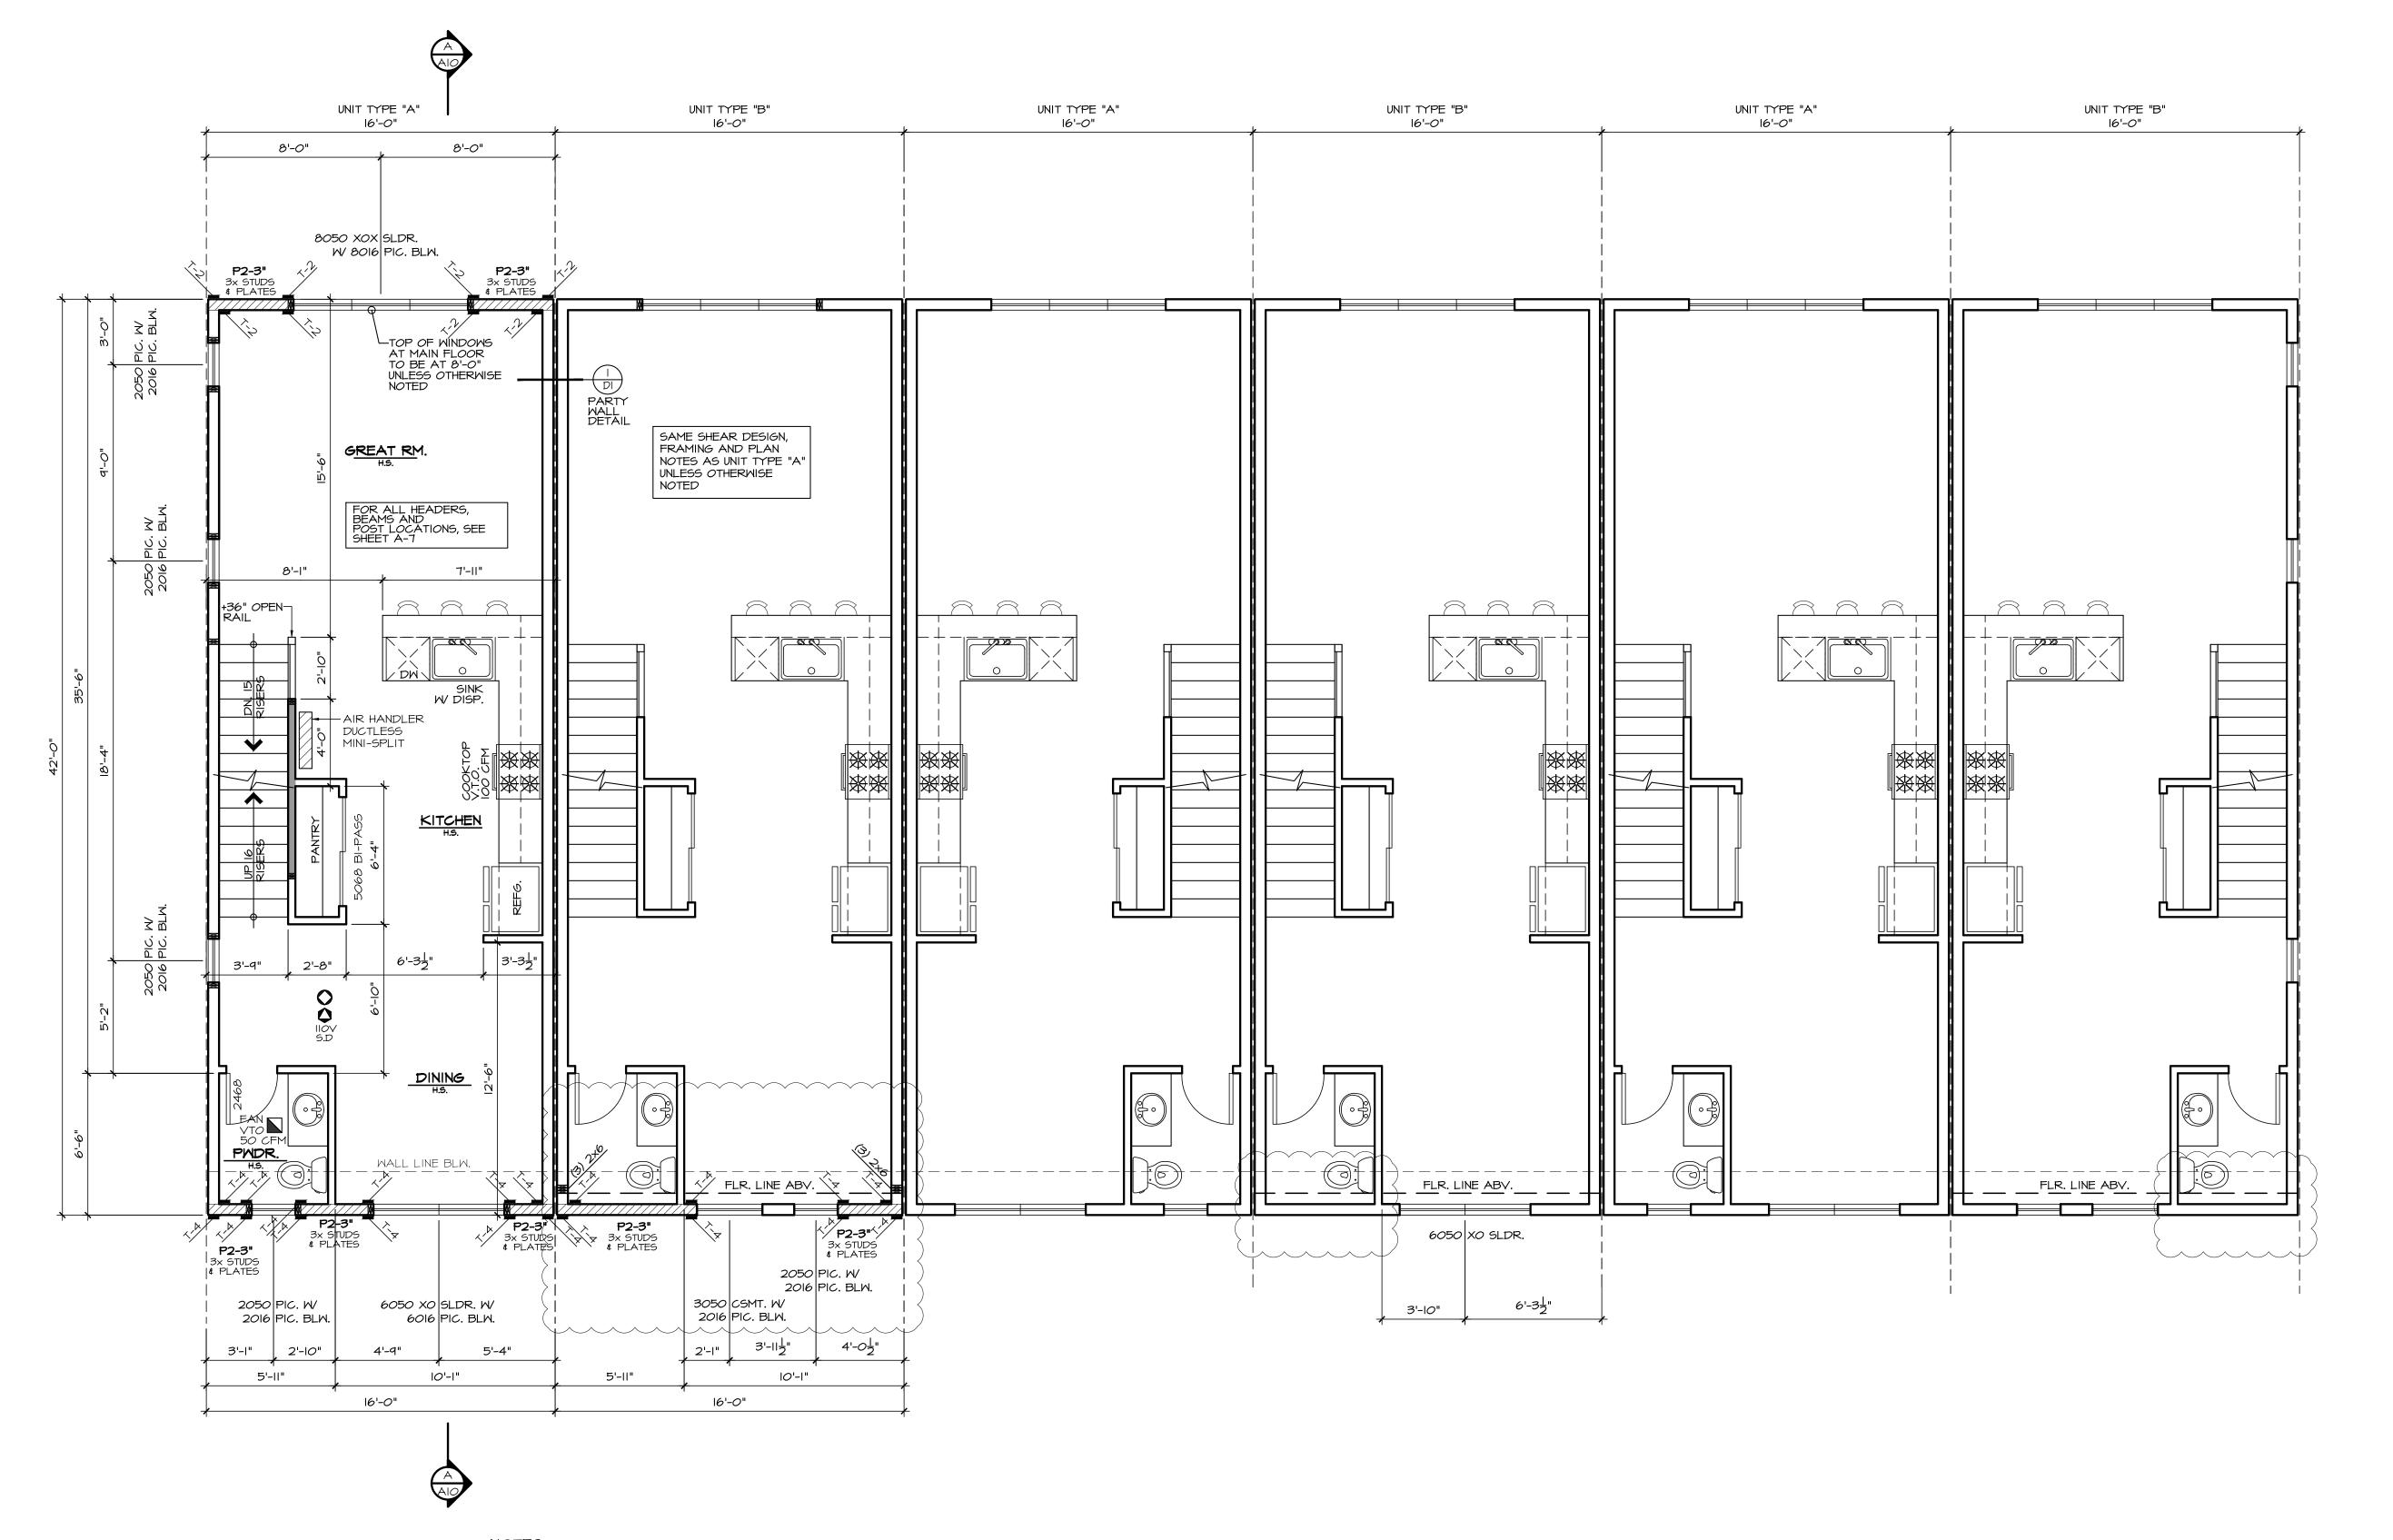MULTIPLE 2x STUDS

POINT LOAD

SMOKE DETECTOR

IIOV INTERCONNECTED

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CARBON MONOXIDE DETECTOR PER IRC 315

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PHOTO ELECTRIC SMOKE ALARMS:
SHALL NOT BE INSTALLED LESS THAN 6'
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INSTALLED COOKING APPLIANCE PER R314

MAIN FLOOR PLAN

SEE GENERAL NOTES

SCALE: 1/4" = 1'-0"



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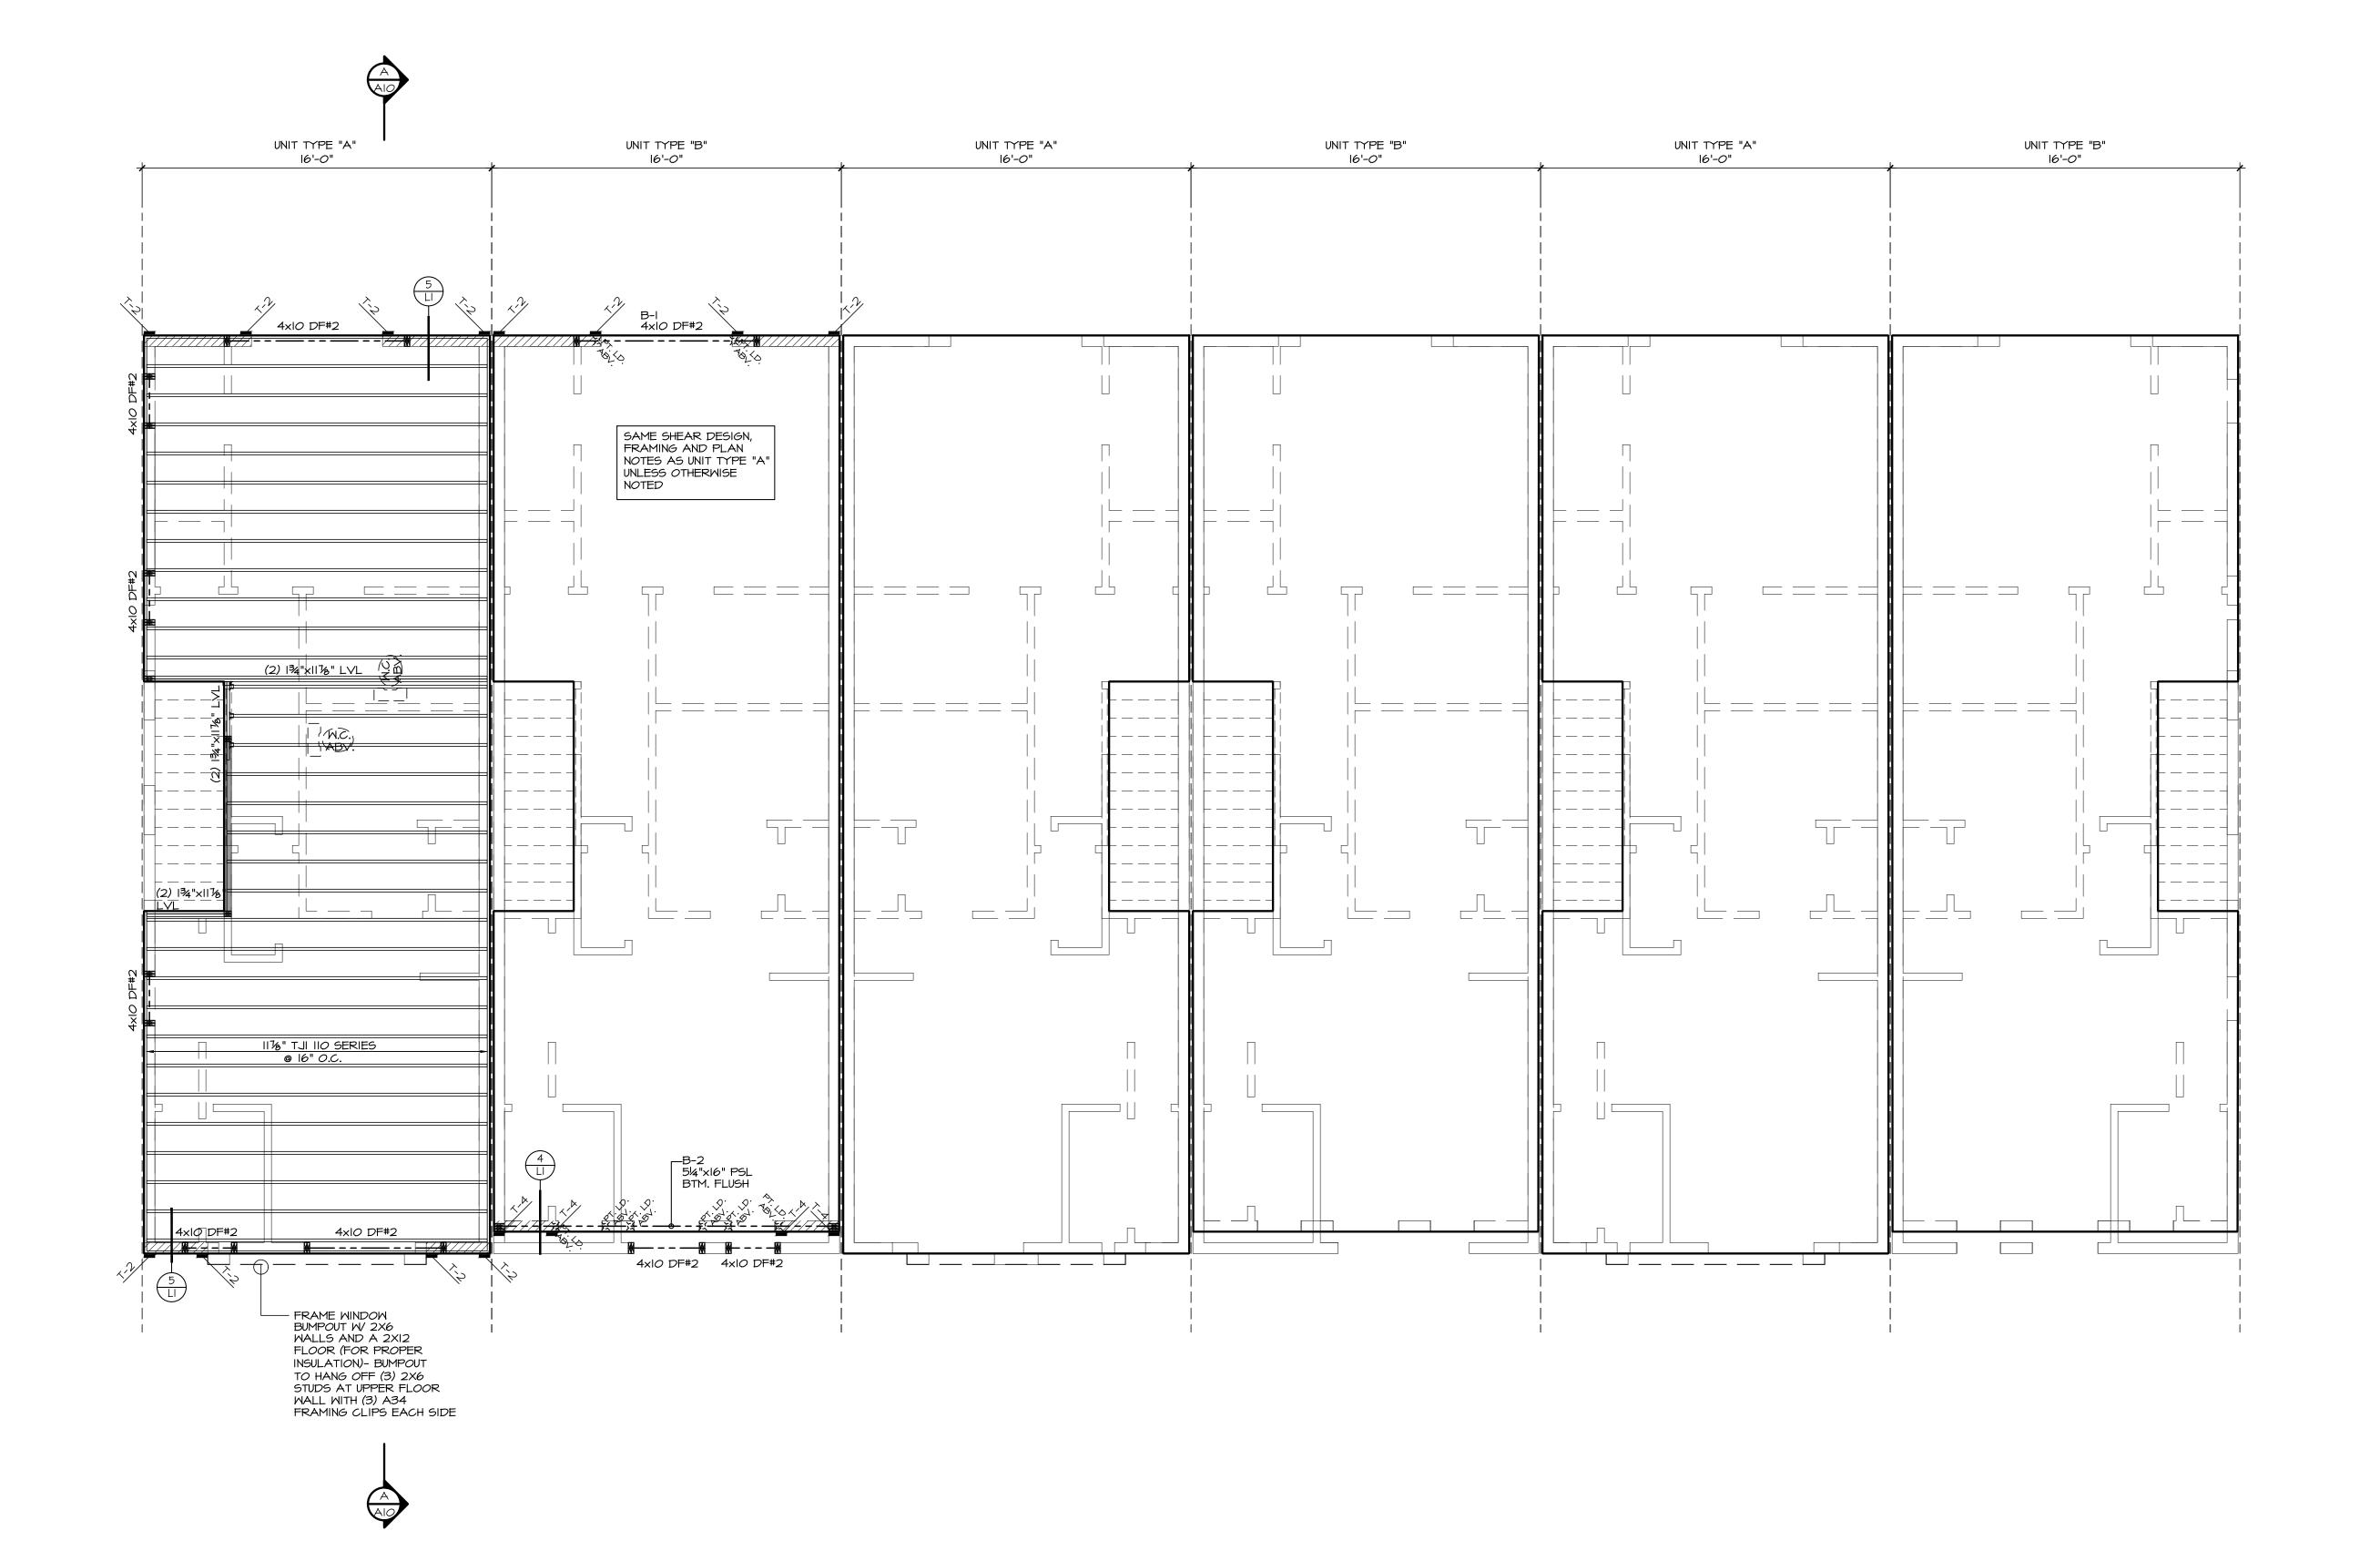
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BEARING ABOVE

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ABV. X

POINT LOAD ABOVE

MULTIPLE 2x STUDS
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CARBON MONOXIDE DETECTOR PER IRC 315 UPPER FLOOR FRAMING PLAN

SEE GENERAL NOTES

SCALE: |/4" = |'-0"



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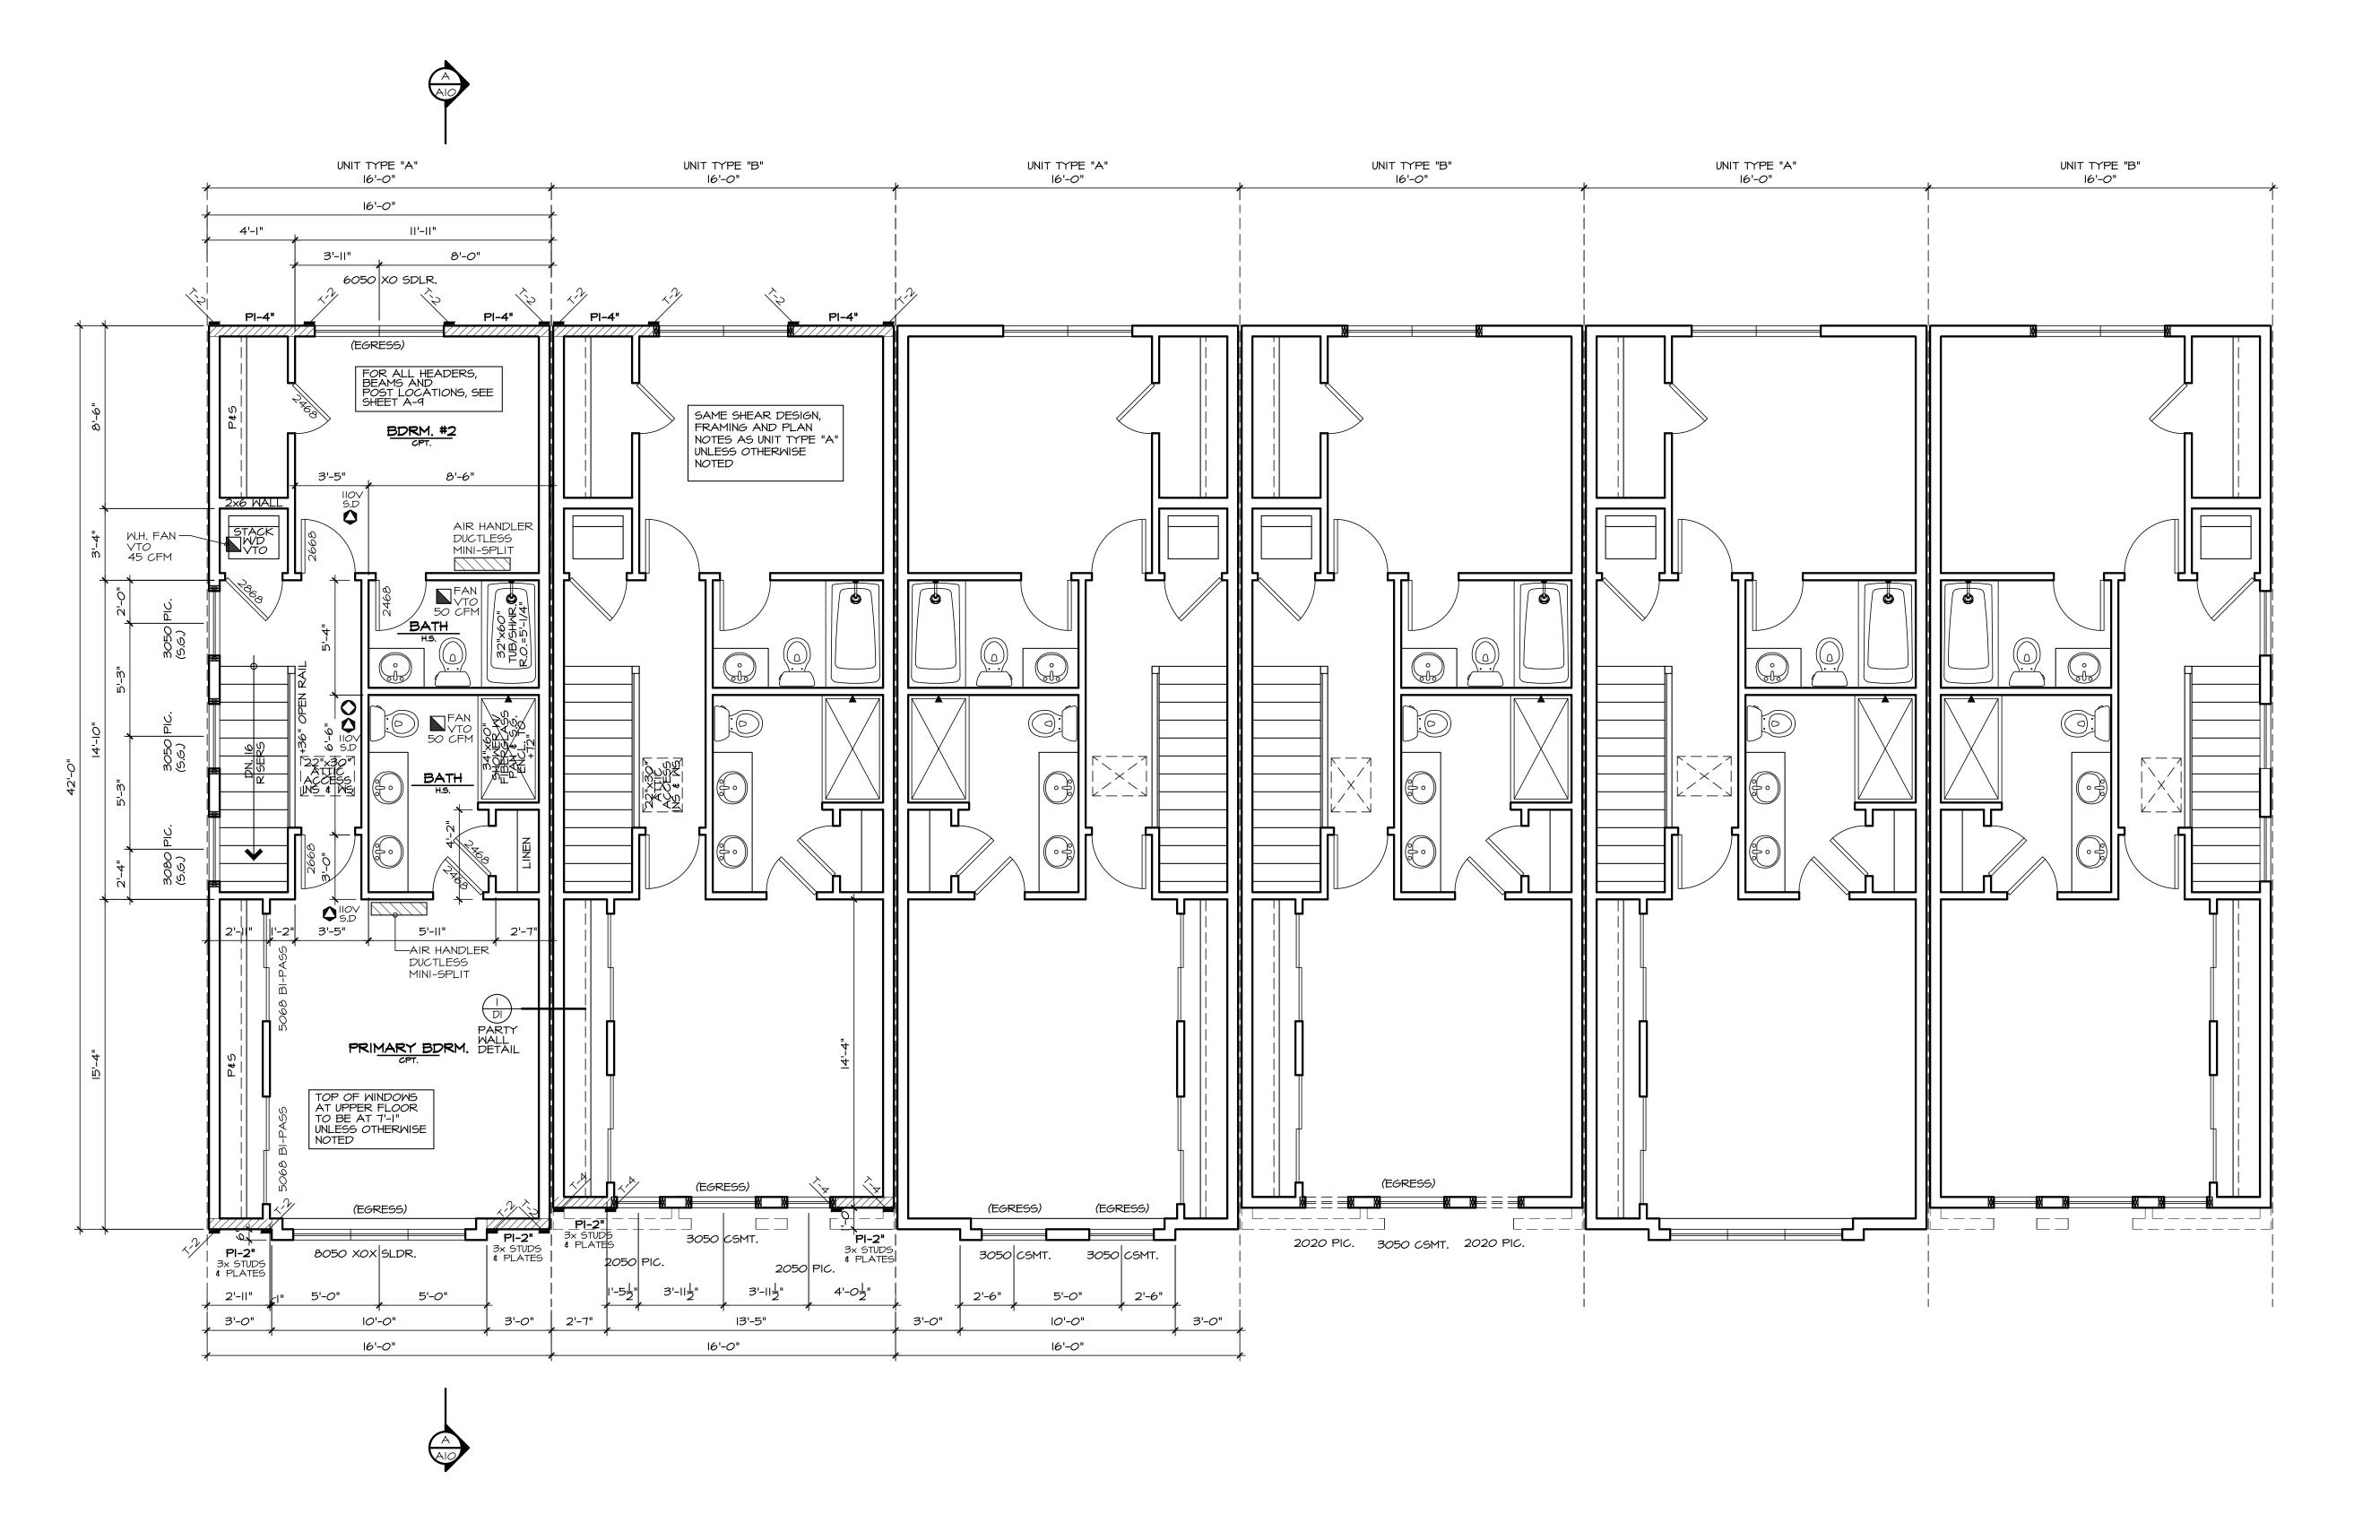
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permit:
revisions:
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drawn by: LMD checked by: MMJ

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LEGEND:

BEARING ABOVE FLOOR LINE ABOVE

POINT LOAD ABOVE MULTIPLE 2x STUDS POINT LOAD

SMOKE DETECTOR
IIOV INTERCONNECTED
W/ BATTERY BACK-UP.
PER IRC 314 CARBON MONOXIDE DETECTOR PER IRC 315

*** SHEAR NOTE: SEE SHEET LI FOR SHEAR WALL NAILING SCHEDULE, & DETAILS. SMOKE DETECTORS SHALL BE INSTALLED NOT LESS THAN 3 FEET HORIZONTALLY FROM THE DOOR OR OPENING OF A BATHROOM THAT CONTAINS A TUB OR SHOWER PER R314

PHOTO ELECTRIC SMOKE ALARMS: SHALL NOT BE INSTALLED LESS THAN 6' HORIZONTALLY FROM A PERMANENTLY


INSTALLED COOKING APPLIANCE PER R314

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UPPER FLOOR PLAN

SEE GENERAL NOTES

SCALE: 1/4" = 1'-0"

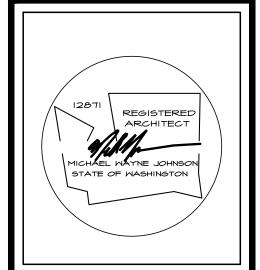


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6-22-22 date:

permit: revisions: 5-1-23

drawn by: LMD checked by: MMJ



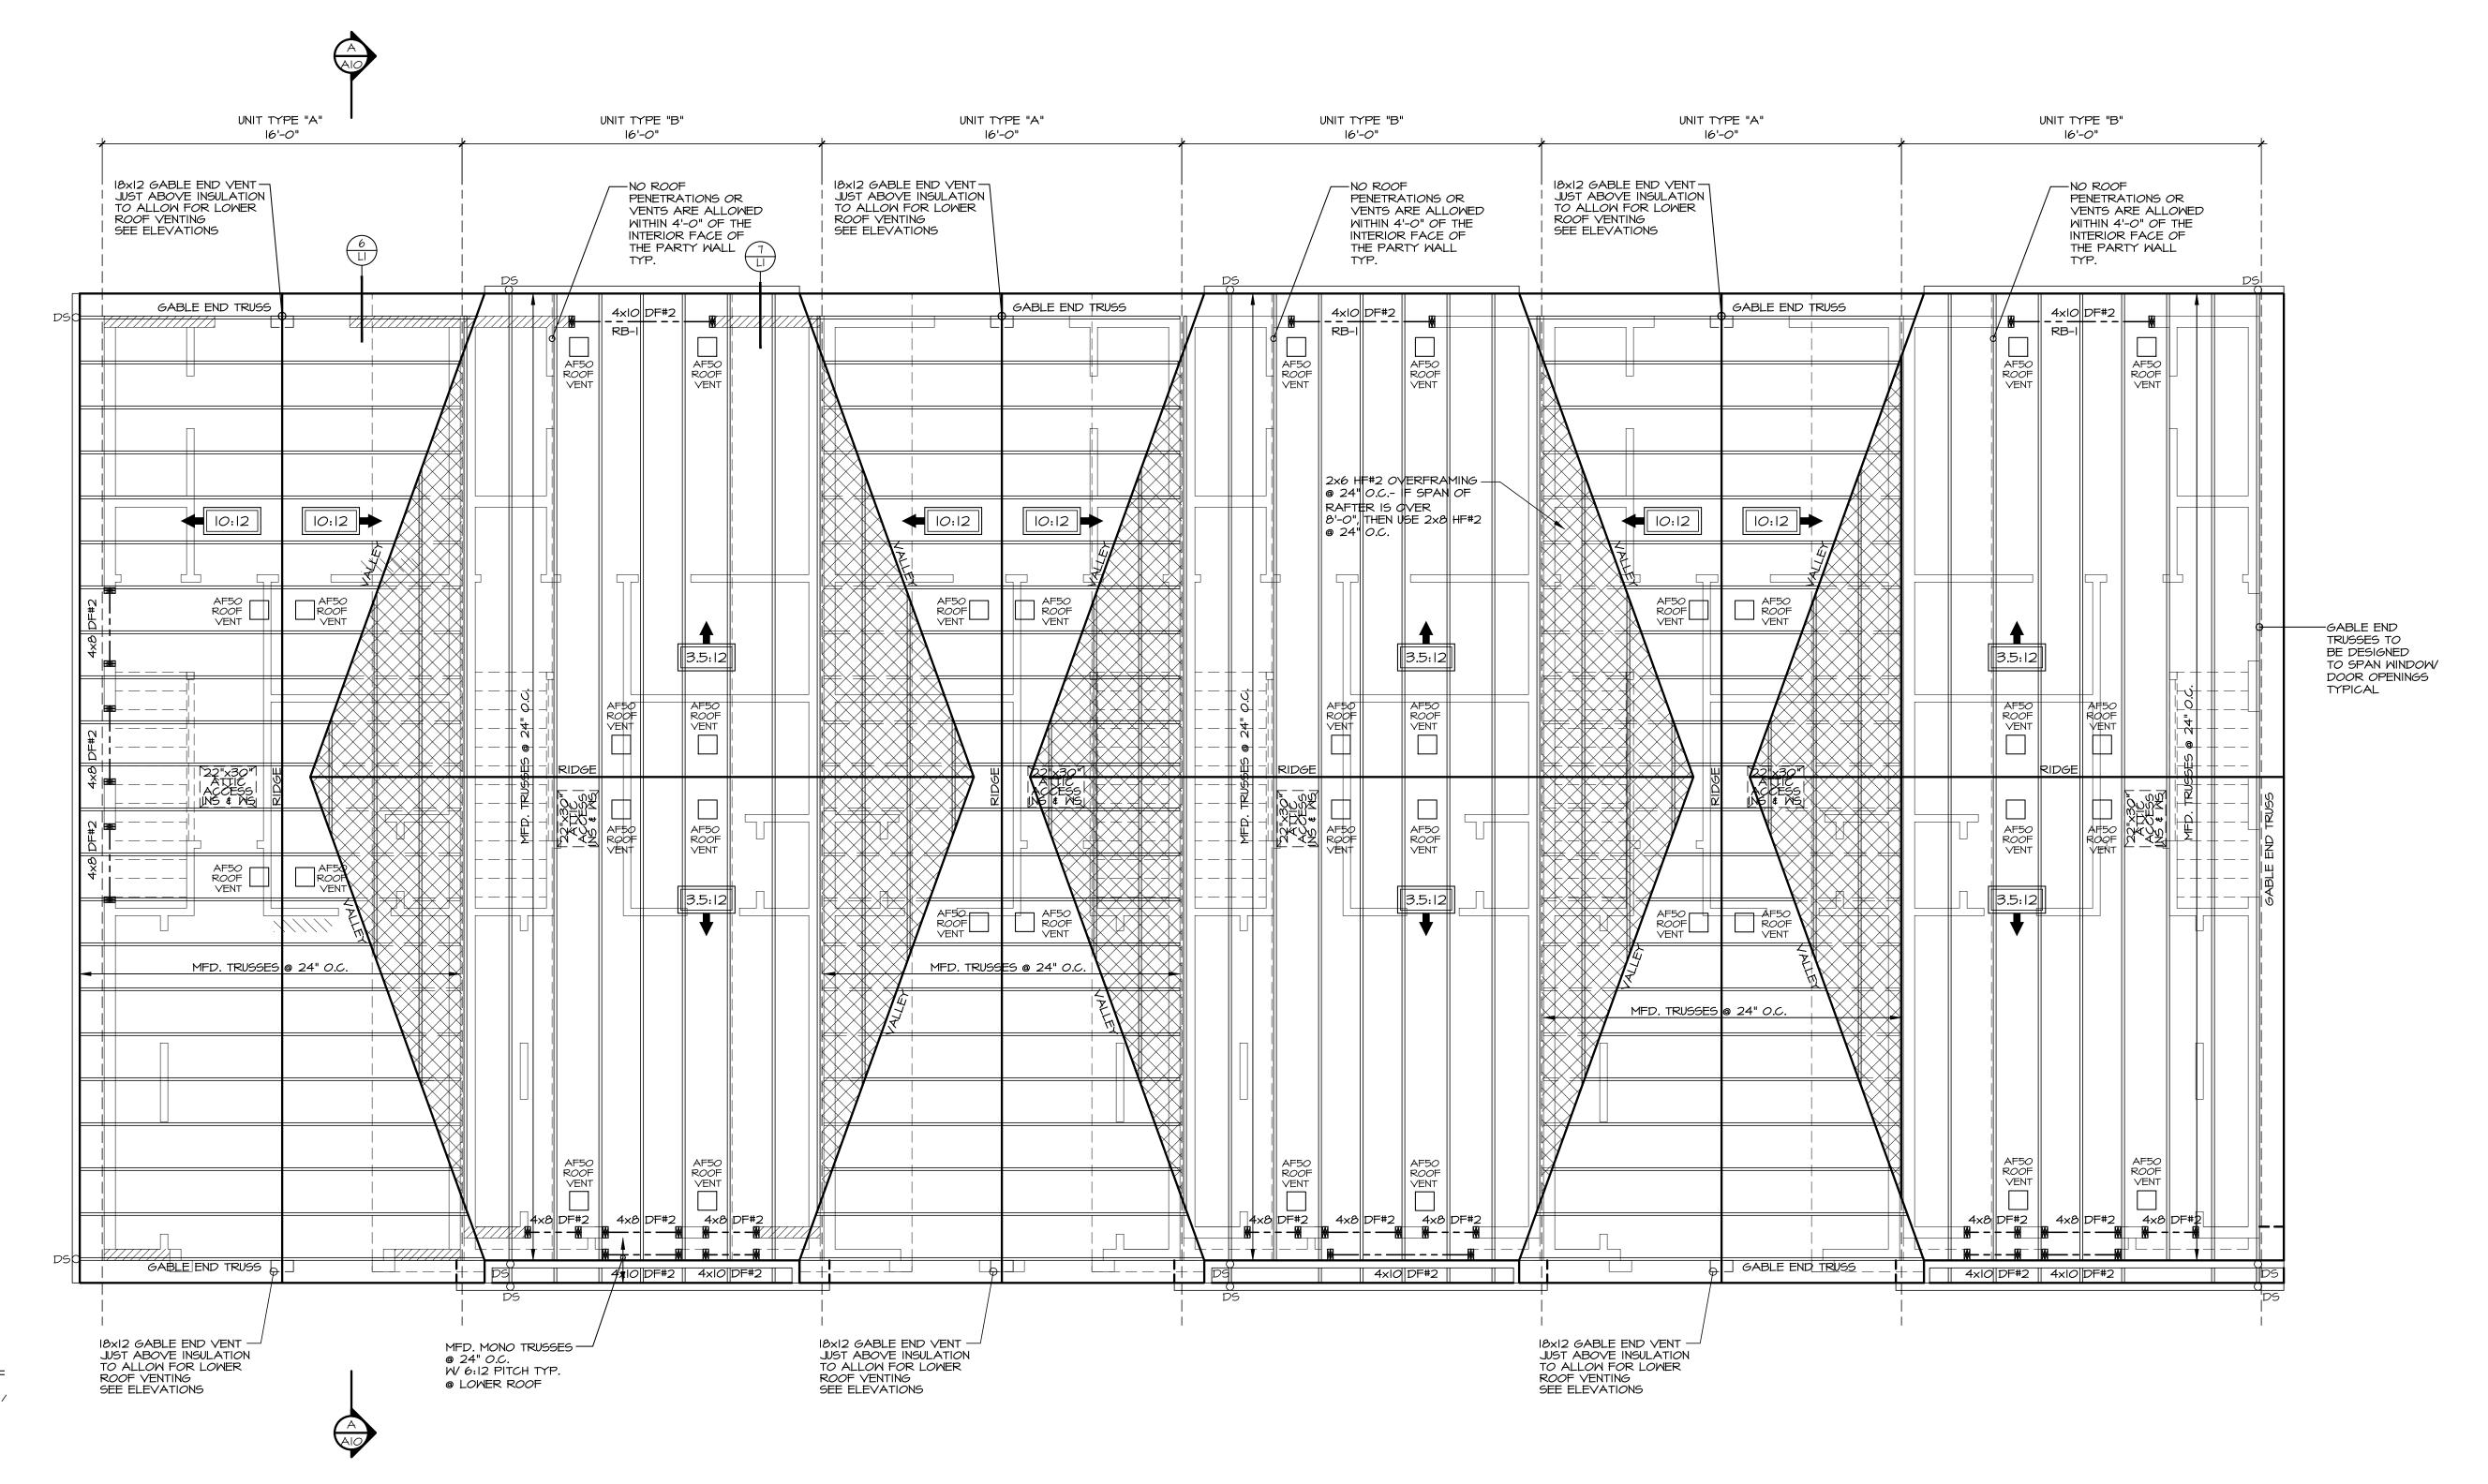

TRUSS NOTE

- ALL TRUSSES SHALL HAVE:

 I. STRESS ANALYSIS AND DRAWINGS /
 DETAILS STAMPED BY A STATE
 REGISTERED ENGINEER.
- MANUFACTURER'S STAMP ON PRE-MANUFACTURED TRUSSES.
- 3. BRACED TO MANUFACTURER'S SPECIFICATIONS.
- 4. STRESS ANALYSIS AND DETAILS
 SHALL BE SUBMITTED TO DESIGN
 PROFESSIONAL FOR APPROVAL AND SHALL
 BE KEPT ON SITE FOR FRAMING
 INSPECTION.
- TRUSSES WILL NOT BE FIELD ALTERED WITHOUT PRIOR BUILDING DEPARTMENT APPROVAL OR ENGINEERING CALCULATIONS.
- 6. ALL TRUSSES SHALL HAVE SIMPSON H-I CLIPS AT ENDS. WHERE TRUSSES ARE PARALLEL TO WALL, USE SIMPSON L3O AT MIDSPAN. USE SIMPSON STC CLIPS AT NON-BEARING WALLS


ROOF FRAMING NOTES

CUT RAFTER TAILS TO MATCH 2x4
TRUSSES

CONNECTORS SHALL BE ENGINEERED
BY TRUSS MANUFACTURER

ROOF PITCH SHALL BE 3.5:12

ROOF PITCH SHALL BE 3.5:12
TYPICAL UNLESS NOTED OTHERWISE
ROOF OVERHANG SHALL BE 12" U.N.O.

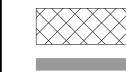

BEARING BELOW

DOWNSPOUT

2×6 OVERFRAMING

ROOF VENTING CALCULATION UNIT TYPE 'B'

627 SQFT AREA = 2.09 SQFT REQUIRED

(2.09) X (50%)= 1.05 SQFT MIN. REQUIRED AT EAVES

AF50 ROOF JACK VENTS @ EAVES = .34 SQFT EACH VENT

PROVIDE 4 AF50 VENTS @ EAVES = 1.36 SQFT PROVIDED

(2.09) X (50%)= 1.05 SQFT MIN.
REQUIRED WITHIN 3' OF THE RIDGE
AF50 ROOF JACK VENTS= .34 SQFT EACH VENT
PROVIDE 4 AF50 VENTS= 1.36 SQFT PROVIDED

TOTAL VENT AREA PROVIDED= 2.72 SQ FT

ROOF VENTING CALCULATION UNIT TYPE 'A'

6|| SQFT AREA = 2.03 SQFT REQUIRED

(2.03) X (50%)= I.OI SQFT MIN. REQUIRED AT EAVES I8XI2 GABLE VENTS= .75 SQFT EACH VENT PROVIDE (2) I8XI2 VENT= I.5 SQFT PROVIDED


(2.03) X (50%)= 1.01 SQFT MIN.
REQUIRED WITHIN 3' OF THE RIDGE
AF50 ROOF JACK VENTS= .34 SQFT EACH VENT
PROVIDE 4 AF50 VENTS= 1.36 SQFT PROVIDED

TOTAL VENT AREA PROVIDED= 2.86 SQ FT



SEE GENERAL NOTES

SCALE: 1/4" = 1'-0"

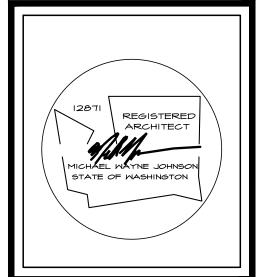

NASH & ASSOCIATES

ARCHITECTS

8003 118TH AVE NE. KIRKLAND, WA. 98033. 425-828-4117

YARDARM GROUP POPLAR POINT UNITS II-16

date: 6-22-22 permit: revisions: 5-1-23

drawn by: LMD checked by: MMJ



2018 WASHINGTON STATE ENERGY CODE


CLIMATE ZONE 5 AND MARINE 4


FENESTRATION U-FACTOR	SKYLIGHT U-FACTOR	GLAZED FENESTRATION SHGC		MOOD FRAMED WALL R-VALUE	FLOOR R-VALUE	BELOW GRADE WALL R-VALUE	SLAB R-VALUE AND DEPTH
0.28	0.50	NR	R-49 (R-38 VAULTED)	R-21	R-38	10/15 R-21 +TB	R-IO, 2 FEET

*TABLE 406.3- ENERGY CREDITS

THIS PLAN REQUIRES 3 CREDITS SINCE IT IS UNDER 1500 SQUARE FEET

OPTION		CREDIT
HEATING OPTION 2	HEAT PUMP (ELECTRIC)	1.0
ENERGY OPTION 3.6	DUCTLESS SPLIT SYSTEM HEAT PUMPS WITH NO ELECTRIC RESISTANCE HEATING IN THE PRIMARY LIVING AREAS. A DUCTLESS HEAT PUMP SYSTEM WITH A MINIMUM HSPF OF IO SHALL BE SIZED AND INSTALLED TO PROVIDE HEAT TO ENTIRE DWELLING UNIT AT THE DESIGN OUTDOOR AIR TEMPERATURE.	2.0
		TOTAL
		3.0 CREDITS

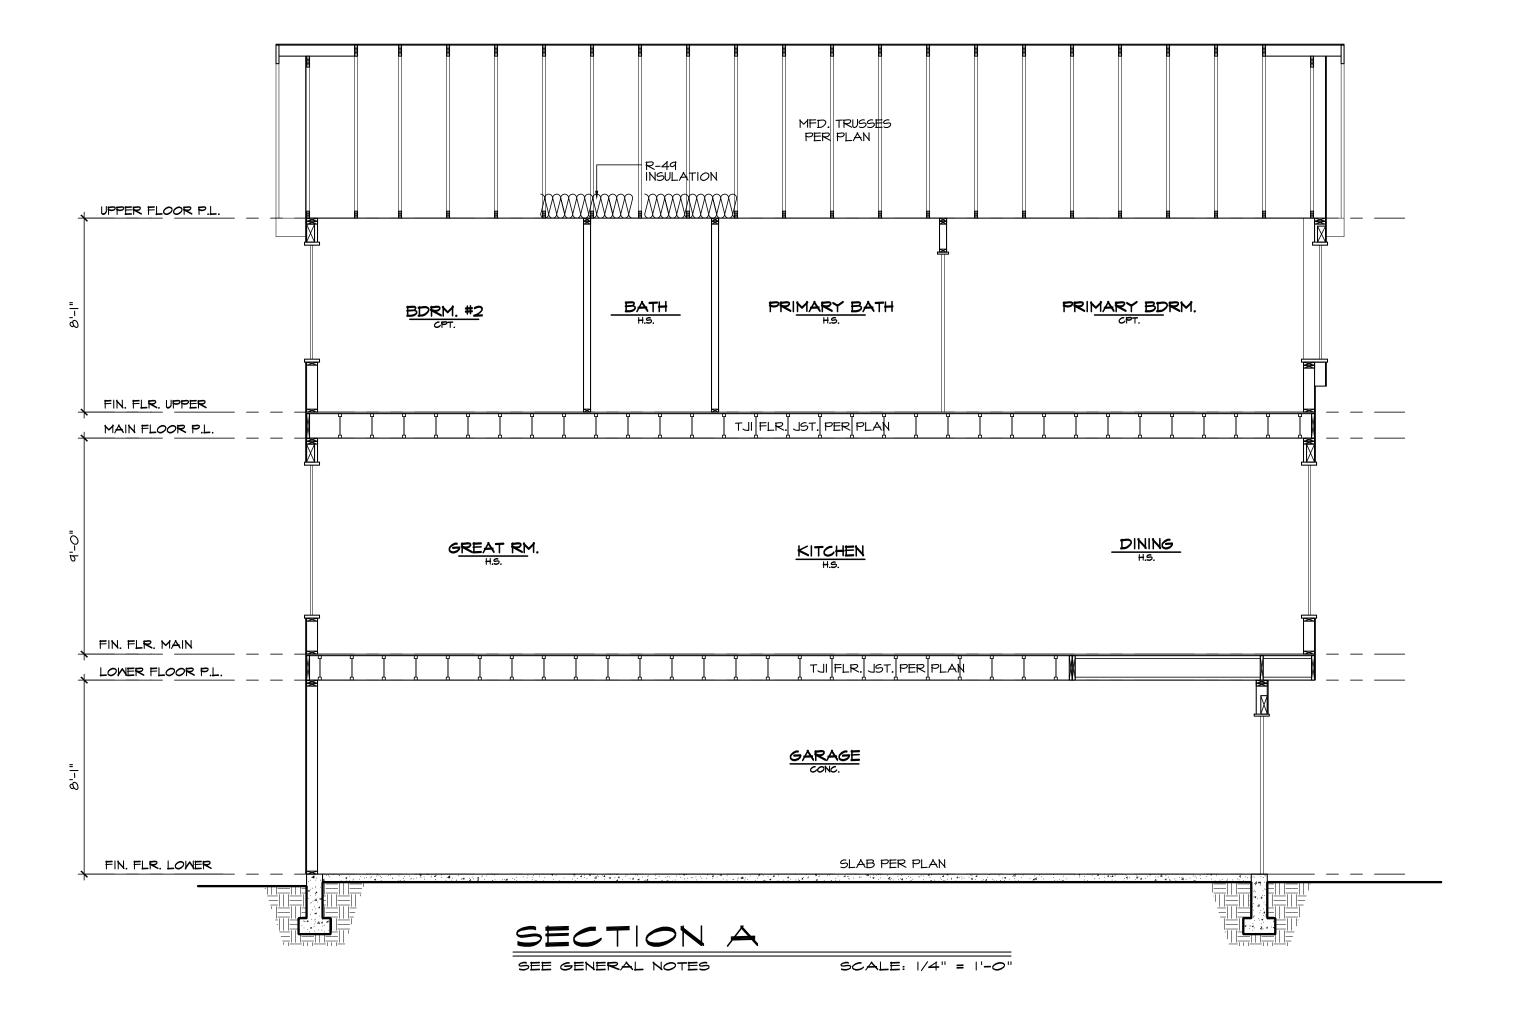


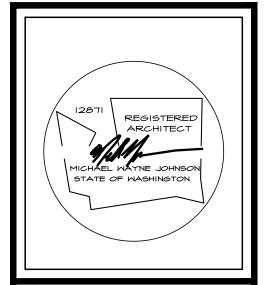

* ASSOCIATES HITECTS NASH A

6-22-22 date: permit: revisions:

drawn by: LMD checked by: MMJ

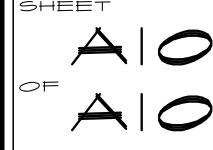

GA FILE NO. WP3370

Reference 20th edition Gypsum Association Fire Resistance Design Manual


FIRE RESISTANCE RATING: 1 HR LOAD-BEARING

SOUND TRANSMISSION RATING (STC): 45 to 49; test: Riverbank Acoustical Labs TL75-83

ASSEMBLY DESCRIPTION:

GYPSUM WALLBOARD, WOOD STUDS

One layer 5/8" type X gypsum wallboard or gypsum veneer base applied parallel or at right angles to each side of double row of 2 X 4 wood studs 16 "o.c. on separate plates 1" apart with 6d coated nails, 1-7/8" long, 0.0915" shank, ¼" heads, 7" o.c. Joints staggered 16" each layer and side. Horizontal bracing required at mid-height. (LOAD-BEARING)

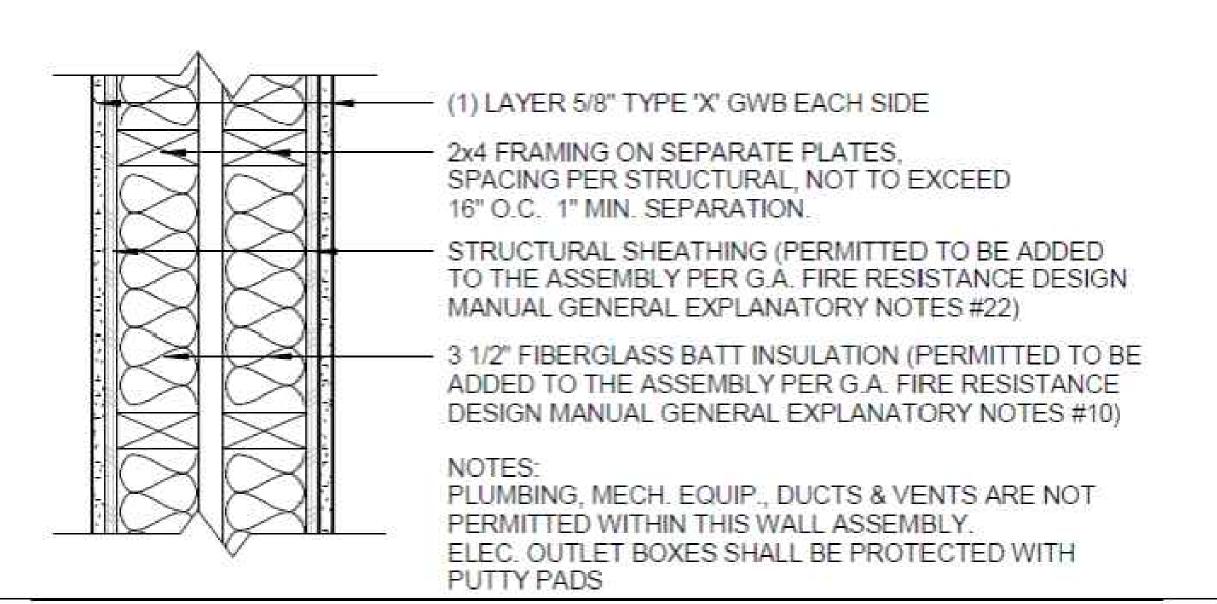





NASH & ASSOCIATES
ARCHITECTS

YARDARM GROUP POPLAR POINT UNITS II-16


date: 6-22-22 permit:


revisions:


drawn by: LMD checked by: MMJ

SHEET

OF

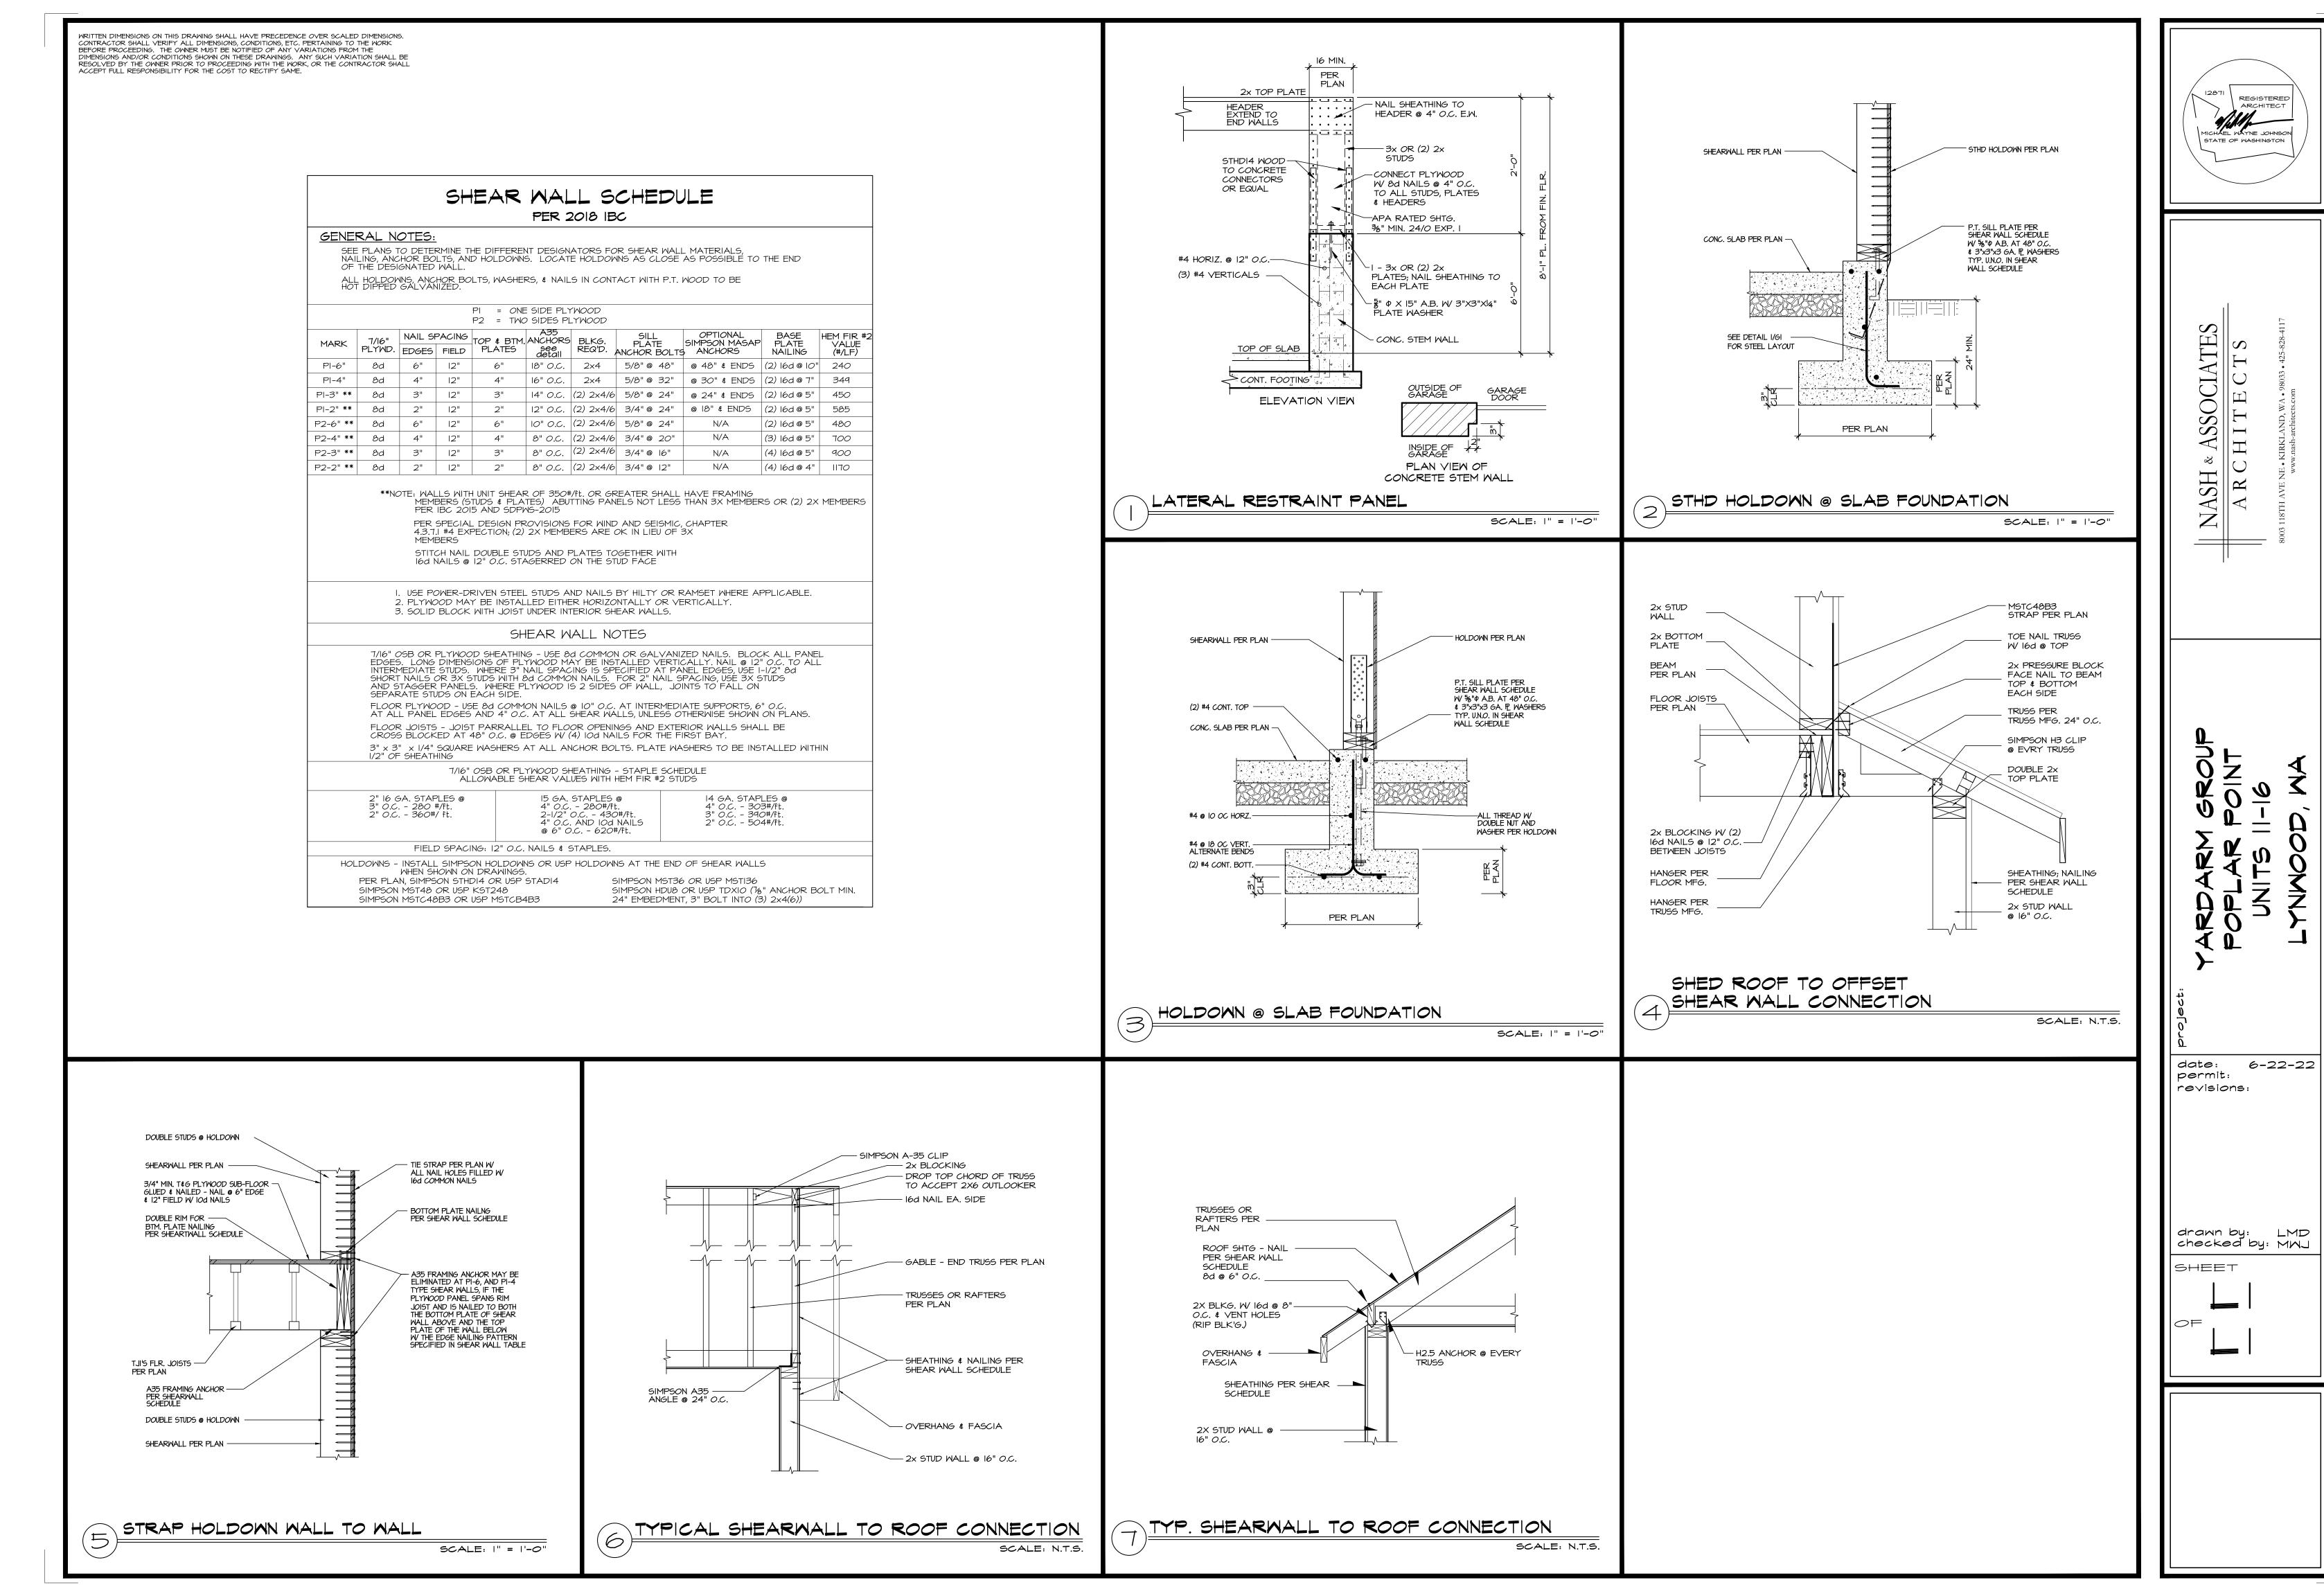

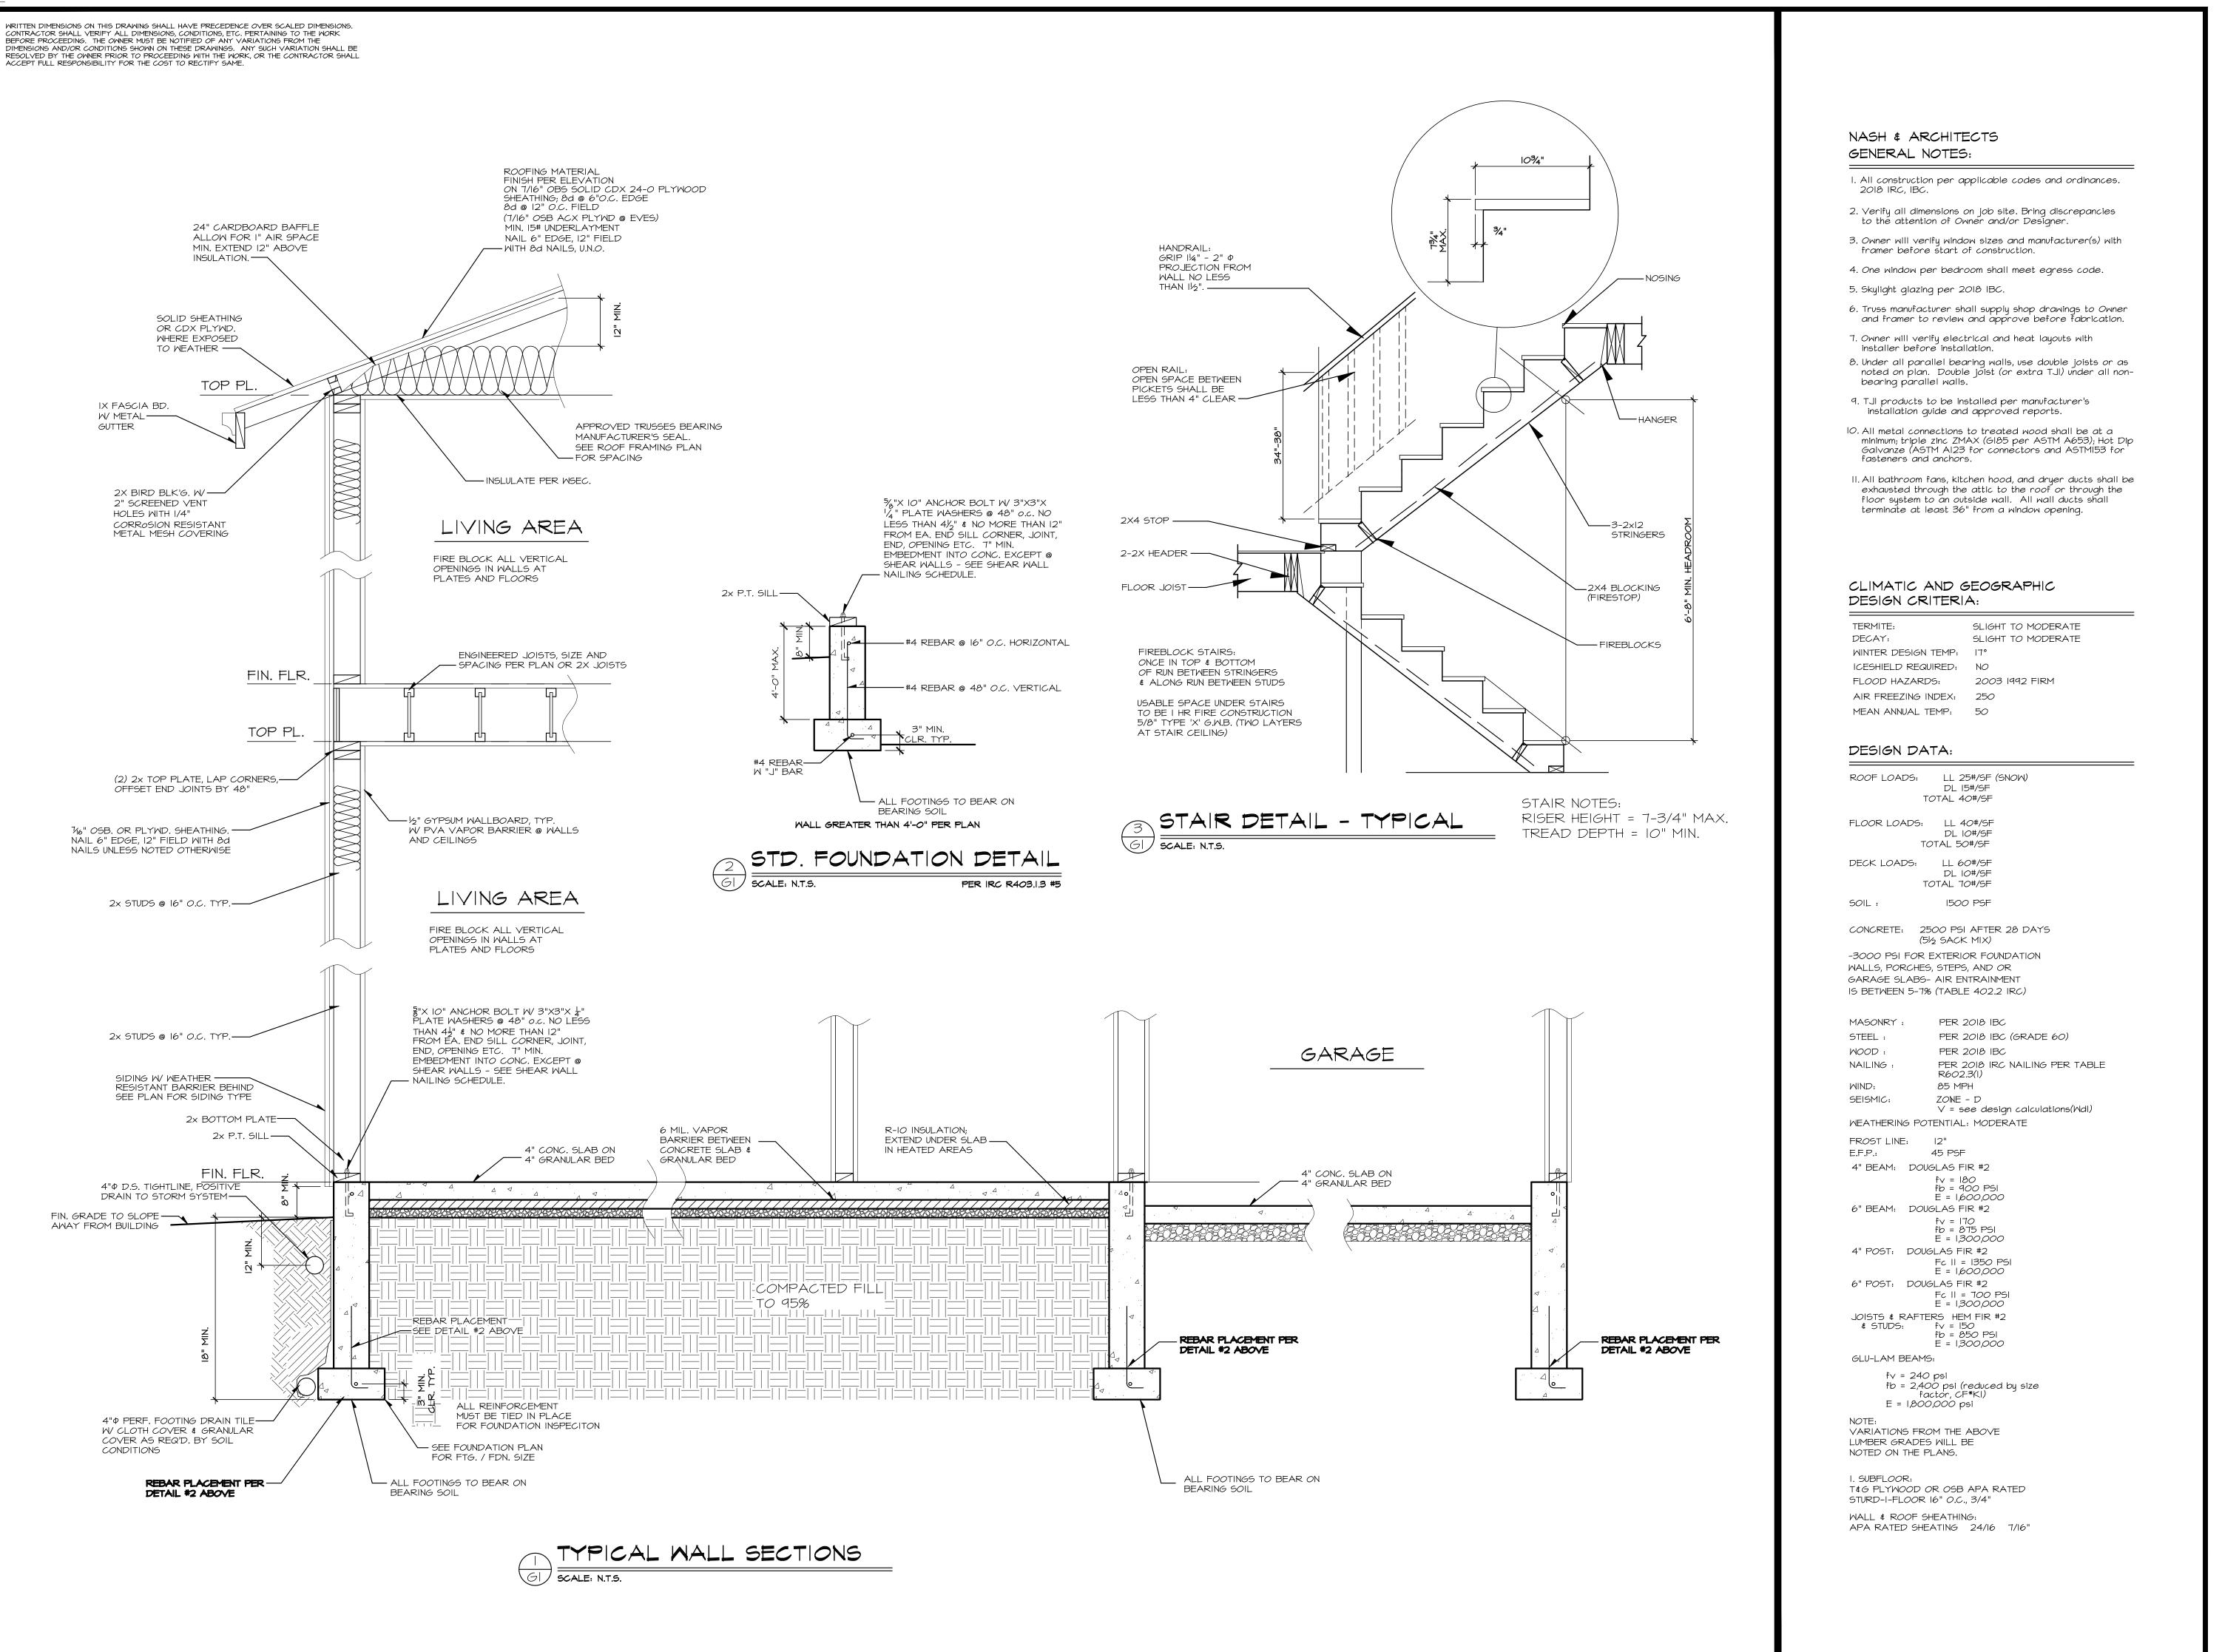

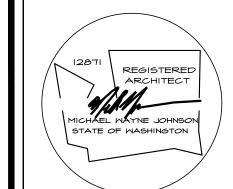

& ASSOCIATES

CHITECTS

SF

4RM 6ROUP 4R POINT 04L NALL

date: 6-22-22 permit: revisions:

drawn by: LMD checked by: MMJ

SHEET

6

6